

INDEX OF SHEETS
SEE SHEET IL1

CITY OF WALTERBORO

PROPOSED PLANS FOR

COLLETON COUNTY
PROJECT ID 0041932
SC 63 (SOUTH JEFFERIES BLVD)
FROM: HAMPTON STREET (SC 63)
TO: BENSON ST (S-15-293)

Hydraulic Design Reference for these plans is the:
2009
Edition of SCDOT's "Requirements for Hydraulic Design Studies"

Design Reference for these plans is the:
2001
AASHTO "A Policy on Geometric Design of Highways and Streets"

NPDES PERMIT INFORMATION

Disturbed Area = 0.42 Acre(s)
Project Area = 2.42 Acre(s)

Approximate Location of Roadway is

Begin
Latitude 32° 54' 6.48"N
Longitude 80° 40' 1.92"W

End
Latitude 32° 54' 14.74"N
Longitude 80° 40' 1.36"W

PROJECT ID 0041932 PROJ. NO. 31588.00
SC 63
SURVEY STA. 62+65.75 TO STA. 71+40.51
SEE SHEETS 6-7

PROJECT ID 0041932 PROJ. NO. 31588.00
SC 63
SURVEY STA. 46+22.44 TO STA. 47+73.11
SEE SHEET TSI



LAYOUT
SCALE 1 INCH = 1250 FEET

ENVIRONMENTAL PERMIT INFORMATION			
USACE PERMIT	<input type="checkbox"/> YES	<input checked="" type="checkbox"/> NO	
NEPA DOCUMENT	<input checked="" type="checkbox"/> YES	<input type="checkbox"/> NO	
401 CERTIFICATION	<input type="checkbox"/> YES	<input checked="" type="checkbox"/> NO	
OCRM CAP	<input type="checkbox"/> YES	<input checked="" type="checkbox"/> NO	
NAVIGABLE WATERS	<input type="checkbox"/> SC	<input type="checkbox"/> USCG	<input type="checkbox"/> USACE <input checked="" type="checkbox"/> N/A

3 DAYS BEFORE DIGGING IN
SOUTH CAROLINA
CALL 811
SOUTH CAROLINA 811 (SC811)
WWW.SC811.COM
ALL UTILITIES MAY NOT BE A MEMBER OF SC811

RAILROAD INVOLVEMENT?
YES NO

TRAFFIC DATA		
2017	ADT	14,300
2037	ADT	15,879
	TRUCKS	10 %

LANDSCAPE ARCHITECTURE FIRM

Wood+Partners Inc. WPI
Landscape Architects
Land Planners

612 S Copeland Street ■ Tallahassee, FL 32304
850.391.0360 ■ Fax 850.386.1010 ■ www.woodandpartners.com

NET LENGTH OF ROADWAY	0.166	MILES
NET LENGTH OF BRIDGES	0.000	MILES
NET LENGTH OF PROJECT	0.166	MILES
LENGTH OF EXCEPTIONS	0.000	MILES
GROSS LENGTH OF PROJECT	0.166	MILES

EQUALITIES IN STATIONING
NONE

NOTE: EXCEPT AS MAY OTHERWISE BE SPECIFIED ON THE PLANS OR IN THE SPECIAL PROVISIONS, ALL MATERIALS AND WORKMANSHIP ON THIS PROJECT SHALL CONFORM TO THE SOUTH CAROLINA DEPARTMENT OF TRANSPORTATION STANDARD SPECIFICATIONS FOR HIGHWAY CONSTRUCTION (2007 EDITION) AND THE STANDARD DRAWINGS FOR ROAD CONSTRUCTION IN EFFECT AT THE TIME OF LETTING.

CONSULTING ENGINEERING FIRM

DAVIS & FLOYD
SINCE 1954

WWW.DAVISFLOYD.COM

SCDOT REVIEW	RIGHT-OF-WAY		CONSTRUCTION	
	INITIAL	DATE	INITIAL	DATE
PRECONSTRUCTION SUPPORT - ROAD				
PRECONSTRUCTION SUPPORT - STRUCTURES				
RPG - DESIGN MANAGER				
RPG - PROGRAM MANAGER				

THE INITIALS ABOVE DO NOT RELIEVE THE ENGINEER OF RECORD OF THE RESPONSIBILITY TO DESIGN THIS PROJECT IN ACCORDANCE WITH ALL APPLICABLE CRITERIA.

For Right Of Way Acquisition:

Consultant Engineer of Record _____ Date _____

Regional Production Engineer _____ Date _____

ENGINEER OF RECORD

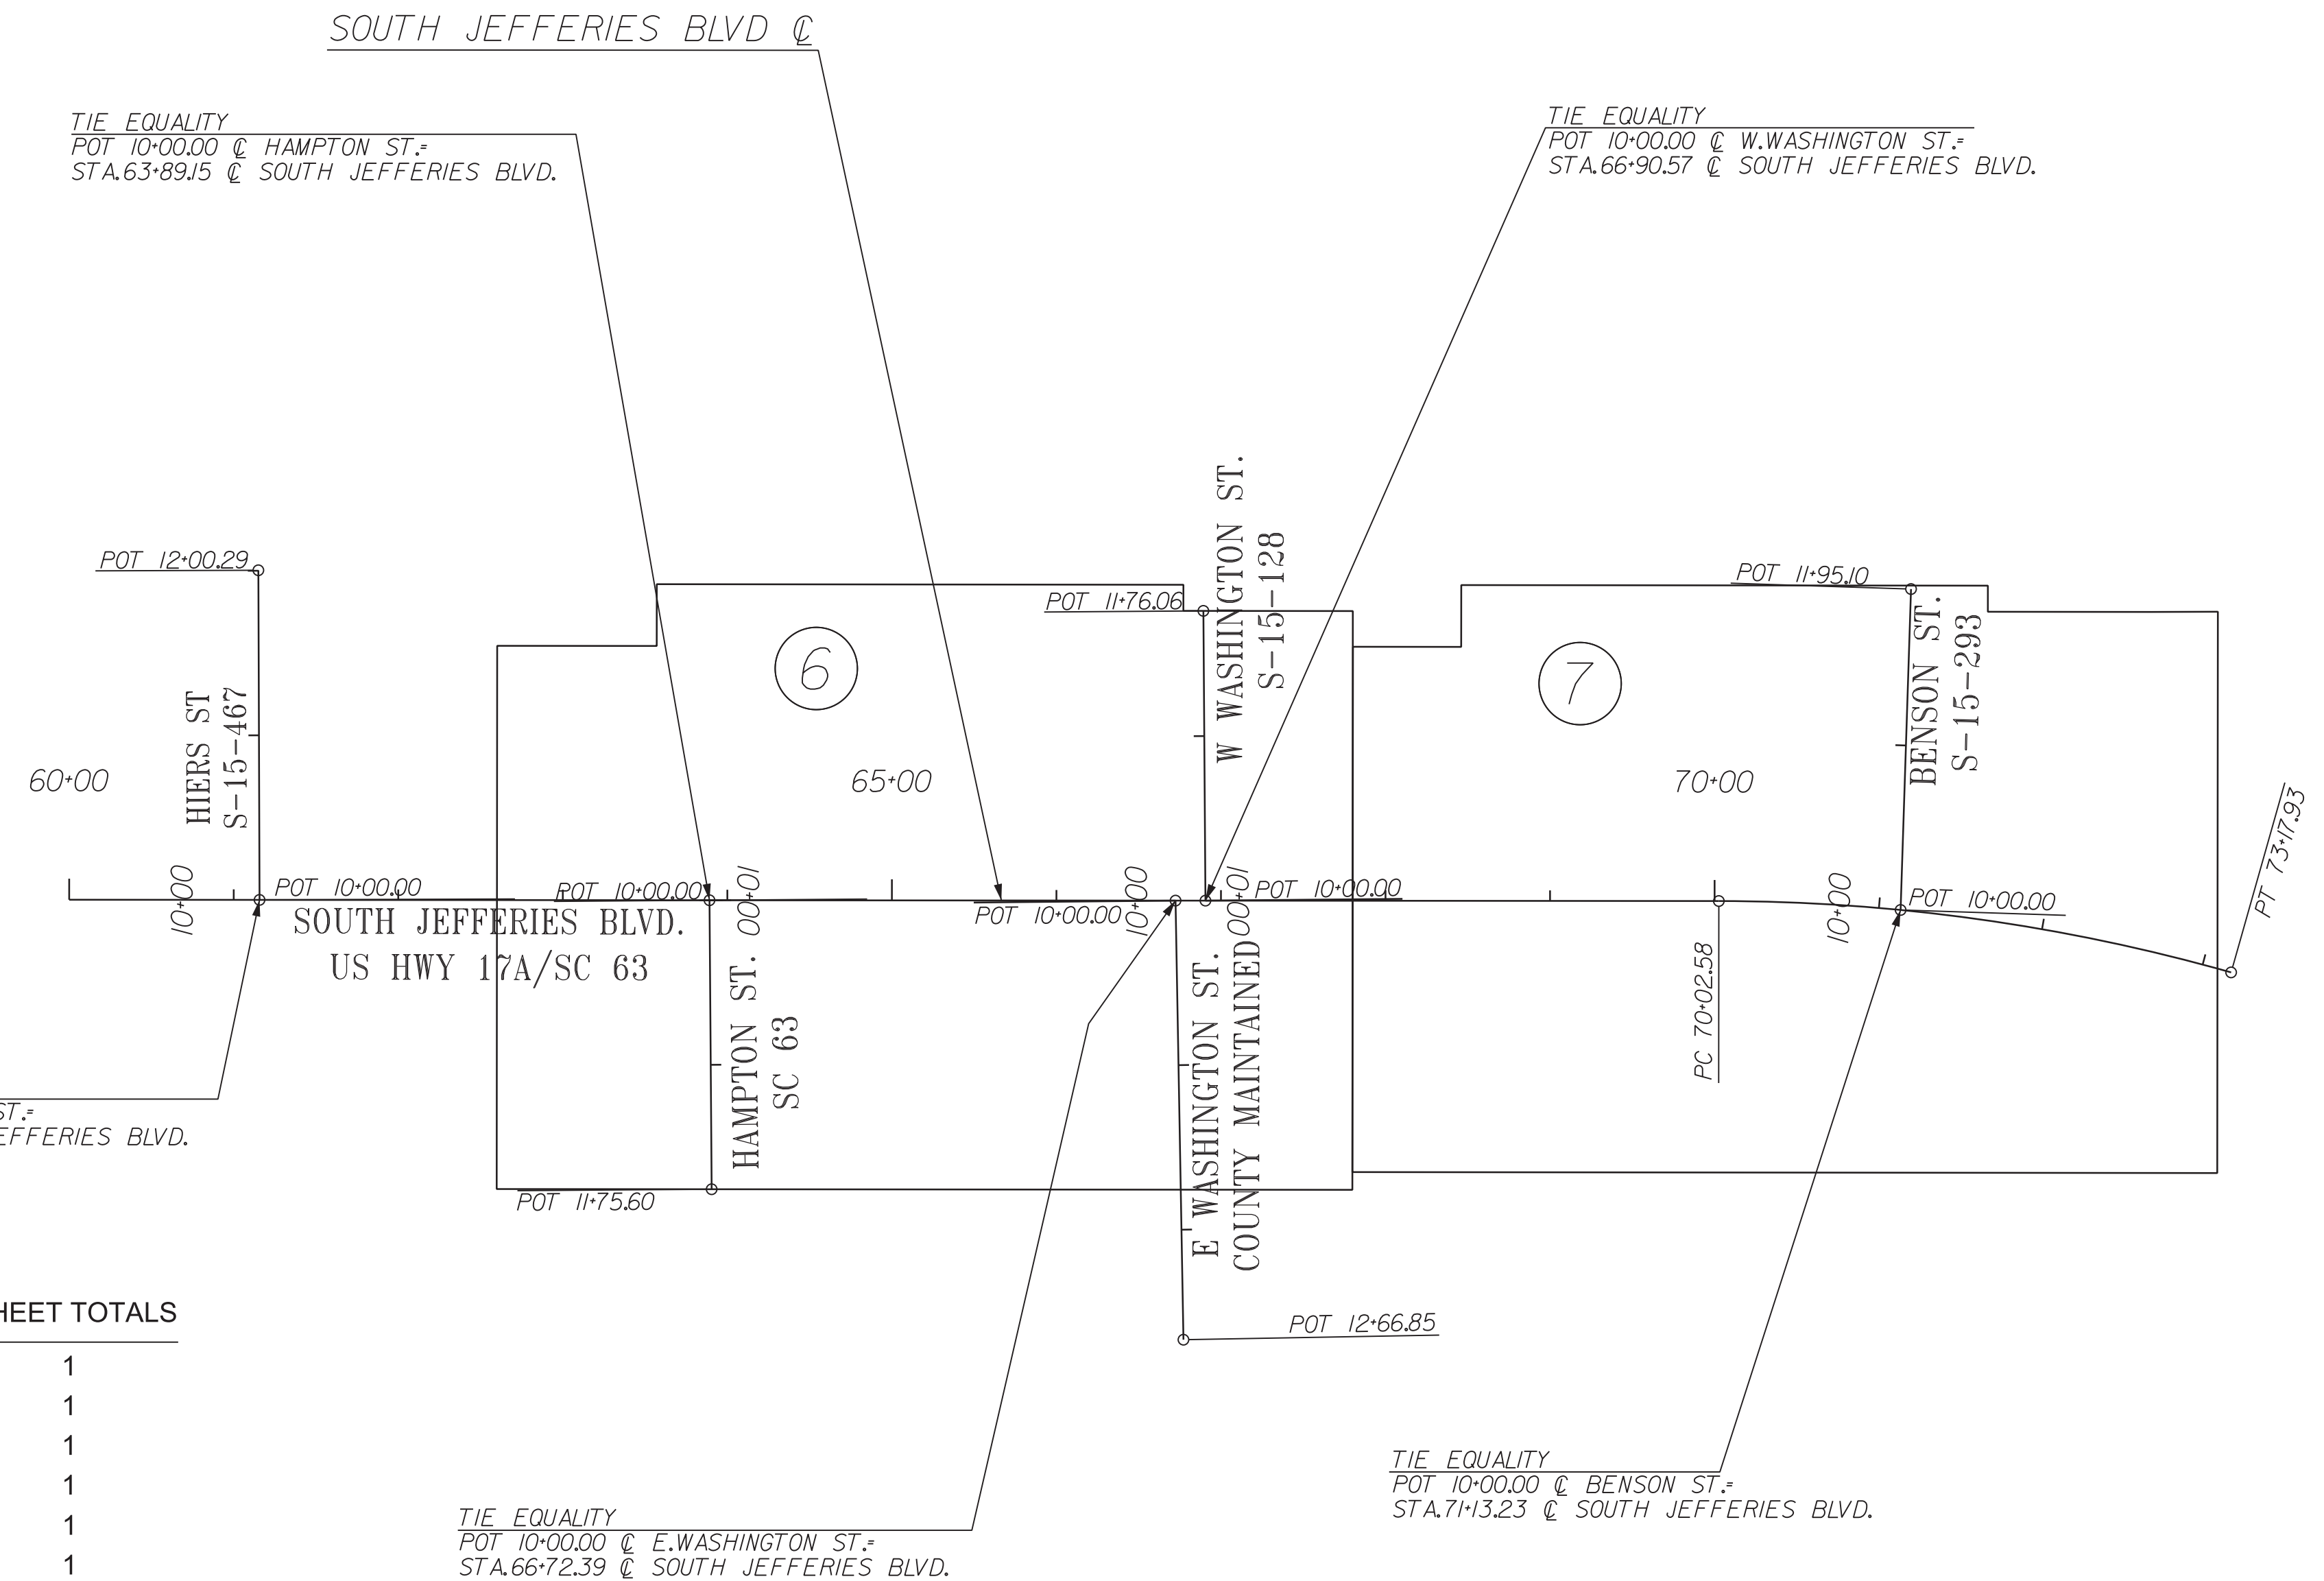
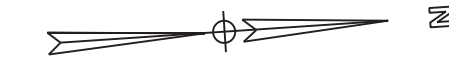
DAVIS & FLOYD, INC.
REGISTERED PROFESSIONAL ENGINEER
No. C00538

GEORGE TILLEY RALL
REGISTERED PROFESSIONAL ENGINEER
No. 20214

FOR CONSTRUCTION: *[Signature]* 08/03/2018
DATE

FED. RD. DIV. NO.	STATE	COUNTY	PROJECT ID	PROJECT NO.	ROUTE NO.	SHEET NO.	TOTAL SHEETS
3	S.C.	COLLETON	0041932	31588.00	SC 63	IL1	

SOUTH JEFFERIES BLVD



INDEX OF SHEETS

SHEET #	DESCRIPTION	SHEET TOTALS
1	TITLE SHEET	1
IL1	INDEX / LAYOUT SHEET	1
2	SUMMARY OF ESTIMATED QUANTITIES	1
2A	REMOVAL AND DISPOSAL ITEMS	1
3	TYPICAL SECTIONS	1
3A	DETAILS	1
4	RIGHT OF WAY DATA SHEET	1
4A	PROPERTY STRIP MAP	1
5	GENERAL CONSTRUCTION NOTES	1
5A	REFERENCE SHEET	1
6 - 7A	PLAN AND PROFILE SHEETS	4
L1 - L8	SITE FURNISHING PLANS AND DETAILS	8
L9-L12	LANDSCAPE PLANS AND DETAILS	4
L13-L19	IRRIGATION PLANS AND DETAILS	7
L20-L30	FOUNTAIN PLANS AND DETAILS	11
PM01 - PM02	PAVEMENT MARKING PLANS	2
TS1 - TS3	TRAFFIC SIGNAL PLANS	3
S1 - S2	STRUCTURE PLANS	2
EC01 - EC02	EROSION CONTROL PLANS	2
X1 - X3	CROSS SECTIONS	3
TOTAL SHEETS		56

DAVIS & FLOYD
SINCE 1954

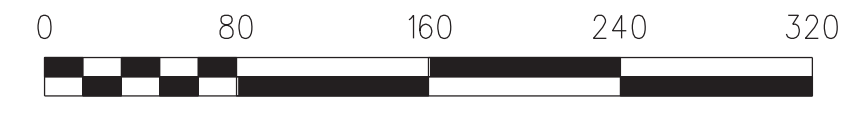
3229 W. MONTAGUE AVENUE
COLUMBIA, SC 29405
(803) 733-2948

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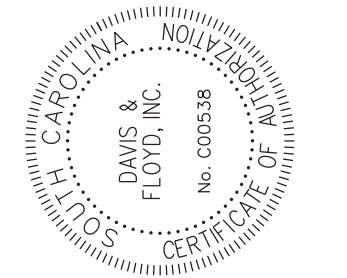
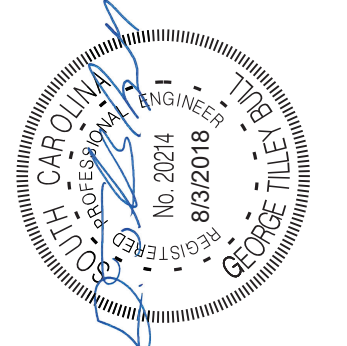
612 S. Capeland Street ■ Tallahassee, FL 32304
850.391.0360 ■ Fax 850.396.1010 ■ www.woodandpartners.com



SCALE: 1" = 80'



PREPARED FOR:
**I-95 BUSINESS LOOP
PHASE 1B
SHEET INDEX**
Walterboro, South Carolina



DGN: LEK
R/W:
CHK: GTB

REVISION	DATE	BY
#		

SHEET NUMBER
IL1

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SUMMARY OF ESTIMATED QUANTITIES

FED. RD. DIV. NO.	STATE	COUNTY	PROJECT ID	PROJECT NO.	ROUTE NO.	SHEET NO.	TOTAL SHEETS
3	S.C.	COLLETON	0041932	31588.00	SC 63	2	

ITEM NO.	DESCRIPTION	UNIT	QUANTITY
1031000	MOBILIZATION	LS	NEC
1032010	BONDS AND INSURANCE	LS	1.000
1050800	CONSTRUCTION STAKES, LINES & GRADES	EA	1.000
1071000	TRAFFIC CONTROL	LS	NEC
1080300	CPM PROGRESS SCHEDULE	LS	NEC
1090200	AS-BUILT CONSTRUCTION PLANS	LS	1.000
2011000	CLEARING & GRUBBING WITHIN RIGHT OF WAY	LS	NEC
2023000	REMOVAL & DISPOSAL OF EXISTING PAVEMENT	SY	1,015.000
2031200	SITE EXCAVATION	LS	NEC
3069900	MAINTENANCE STONE	TON	50.000
6051120	PERMANENT CONSTRUCTION SIGNS (GROUND MOUNTED)	SF	272.000
6250015	8" WHITE SOLID LINES(CROSSWALK&CHANNELIZATION)FAST DRY PAINT	LF	860.000
6250025	24" WHITE SOLID LINES (STOP/DIAGONAL LINES)-FAST DRY PAINT	LF	200.000
6250110	4"YELLOW SOLID LINE(PVT.EDGE&NO PASSING ZONE)-FAST DRY PAINT	LF	95.000
6271015	8" WHITE SOLID LINES THERMOPLASTIC - 125 MIL.	LF	860.000
6271025	24" WHITE SOLID LINES (STOP/DIAG LINES)-THERMO.-125 MIL.	LF	200.000
6271074	4" YELLOW SOLID LINES(PVT.EDGE LINES) THERMO-90 MIL.	LF	95.000
6319505	REMOVAL OF PAVEMENT MARKINGS	LF	770.000
6510105	FLAT SHEET, TYPE III, FIXED SZ. & MSG. SIGN	SF	69.000
6513020	MOUNTING ASSEMBLY FOR F.S. SIGN ERCTD ON MAST ARM	EA	10.000
6531210	U-SECTION POST FOR SIGN SUPPORTS - 3P	LF	44.000
6750275	FURNISH & INSTALL 1.0" SCHEDULE 80 PVC CONDUIT	LF	295.000
6750278	FURNISH & INSTALL 2.0" SCHEDULE 80 PVC CONDUIT	LF	860.000
675027C	FURNISH & INSTALL 3.0" SCHEDULE 80 PVC CONDUIT	LF	92.000
6760060	FURNISH & INSTALL 2" SCHEDULE 80 HDPE CONDUIT (TRENCHLESS)	LF	805.000
6770388	FURNISH & INSTALL NO. 14 COPPER WIRE, 4 CONDUCTOR - BLACK	LF	2,055.000
6770389	FURNISH & INSTALL NO. 14 COPPER WIRE, 4 CONDUCTOR - GRAY	LF	2,510.000
6770393	FURNISH & INSTALL NO. 14 COPPER WIRE, 8 CONDUCTOR (BLACK)	LF	3,000.000
6770394	FURNISH & INSTALL NO. 14 COPPER WIRE, 8 CONDUCTOR (GRAY)	LF	875.000
6770413	FURNISH & INSTL NO. 14 COPPER WIRE, 1-CONDUCTOR FOR LOOP WIRE	LF	3,185.000
6780495	SAWCUT FOR LOOP DETECTOR	LF	1,295.000
6800500	MOD. EXIST ELECTRICAL SERVICE FOR TRAFFIC SIGNAL	EA	3.000
6800518	F&I-13"X24"X18"D.ELEC. FLUSH UNDRD.ENCLDS-(STR.POLY.CONC.)HD	EA	15.000
6825118	21' STEEL POLE WITH 42' MAST ARM	EA	1.000
6825119	21' STEEL POLE WITH 44' MAST ARM	EA	2.000
S000001	21'STL.POLE W/90D.ARMS-30'X36'	EA	1.000
S000002	21'STL.POLE W/90D.ARMS-46'X56'	EA	1.000
S000003	21'STL.POLE W/90D.ARMS-46'X66'	EA	1.000
6825484	FURNISH & INSTALL 10' BREAK-AWAY ALUM PEDESTAL POLE AND BASE	EA	5.000
6845511	F&I - CONTR 332/336 CABINET ASSEMBLY - BASE MOUNTED	EA	3.000
6865710	F&I - 12" 1-WAY-5 SEC(R.Y.YA.G.GA)VEHICLE TRAFFIC SI	EA	2.000
6865722	F&I - 12" 1-WAY-4 SECTION(RA.YA.YAF.GA)VEH TRAFFIC SIGNAL	EA	3.000
6865723	F&I - 12" 1-WAY-3 SECTION(RA.YA.YAF)VEH TRAFFIC SIGNAL	EA	1.000
6865731	F&I - 12" 1-WAY-3 SECTION(R.Y.G.)VEHICLE TRAFFIC SIGNAL	EA	16.000
6865782	F&I - 1-WAY-1SECT.HAND/MAN COUNTDOWN PEDESTRIAN SIGNAL HEAD	EA	14.000
6865791	F&I -PEDESTRIAN PUSH BUTTON STATION ASSEM AND SIGN (R-10-3E)	EA	14.000
6865831	VEHICLE TRAFFIC SIGNAL HEAD MOUNTING ASSEMBLY FOR MAST. ARM	EA	22.000
6865834	BACKPLATE W/ RETROREFL.BORDERS FOR TRAFF. SIG.	EA	22.000
6865840	F&I-PEDESTRIAN TRAF. SIGNAL HEAD MOUNTING ASSEM FOR POST TOP	EA	2.000
6865841	F&I - PED TRAF. SIGNAL HEAD MOUNTING ASSEMBLY FOR SIDE POLE	EA	6.000
6865842	F&I-PED. TRAF. SIGNAL HEAD MOUNT. ASSY FOR DUAL POST TOP	EA	3.000
6885991	REMOVAL,SALVAGE.&DISP.OF EXISTING TRAF. SIGNAL EQUIPMENT	EA	3.000
6885992	TEMPORARY ADJUSTMENT OF TRAFFIC SIGNAL EQUIPMENT	LS	1.000
6887951	FURNISH & INSTALL CONCRETE CABINET FOUNDATION	EA	3.000
6888255	INSTALL LOOP DETECTOR AMPLIFIER	EA	22.000
S000004	F&I MAST ARM STYLE 56C LUMINAIRE ASSEMBLY	EA	6.000
7201100	CONCRETE CURB (TRANSITION)	LF	6.000
7203210	CONCRETE CURB AND GUTTER(2'-0") VERTICAL FACE	LF	81.000



ITEM NO.	DESCRIPTION	UNIT	QUANTITY
7204110	CONCRETE SIDEWALK(4" UNIFORM) OYSTER SHELL FINISH	SY	1,015.000
7204900	DETECTABLE WARNING MATERIAL	SF	87.500
7209000	PEDESTRIAN RAMP CONSTRUCTION	SY	175.000
8021204	4" PERFORATED PIPE UNDERDRAIN	LF	192.000
8091010	RIGHT OF WAY MARKER(REBAR AND CAP)	EA	33.000
8091050	RIGHT OF WAY PLAT	LS	1.000
8100200	TEMPORARY COVER	ACRE	0.083
8109901	MOWING	ACRE	0.083
8131000	SODDING	SY	600.000
8151203	HYDRAULIC EROSION CONTROL PRODUCT (HECP) - TYPE 3	ACRE	0.083
8152004	INLET STRUCTURE FILTER - TYPE F (WEIGHTED)	LF	70.000
8153000	SILT FENCE	LF	550.000
8156219	INLET STRUCTURE FILTER - TYPE A	LF	56.000
S000005	CONCRETE DRIVEWAY (6" UNIFORM) OYSTER SHELL FINISH	EA	330.000
S000006	HISTORIC CONCRETE WALL	LF	190.000
S000007	FOUNTAIN UTILITY CONNECTIONS (WATER, SEWER, ELECTRICAL)	LS	1.000
S000008	Tree Protection Fencing	LF	940.000
S000009	Tree Mitigation	LS	1.000
S000010	Brick Paver Plaza - Herringbone Pattern w/ Double Row Soldier Course Edges	SF	1,936.000
S000011	Brick Bands - Double Row Soldier Course in Sidewalks	SF	1,019.000
S000012	Bluestone Pavers	SF	311.000
S000013	Brick Landscape Curb	LF	64.000
S000014	Brick Site Walls	LF	42.000
S000015	Brick Site Wall Columns	EA	4.000
S000016	Existing Wall End Rebuild (SW corner plaza)	EA	1.000
S000017	Bollard (to match those at SE corner of Washington St)	EA	14.000
S000018	Bench (to match those at SE corner of Washington St)	EA	7.000
S000019	Fountain Equipment (Sheets L20 thru L30)	LS	1.000
S000020	Fountain Structure (Sheets L7 & L8)	LS	1.000
S000021	Azalea Southern Indica Hybrid 'Formosa' Formosa Azalea	EA	15.000
S000022	Rosa x 'Double Knockout' Double Knockout Rose	EA	12.000
S000023	Viburnum davidii David Viburnum	EA	30.000
S000024	ANNUALS (To be selected by City P&R Dept.)	SF	701.000
S000025	CU Structural Soil (12"x10"x2' per tree in tree well)	CY	89.000
2031100	ORGANIC TOPSOIL	CY	27.000
8110221	PINE STRAW MULCH, 3" DEPTH	SF	620.000
811114B	LAGERSTROEMIAFAUREI'NATCHEZ"(CRAPE MYRTLE)10'-12',45GAL	EA	11.000
8111182	SABAL PALMETTO 14" CAL 16' - 18' HEIGHT	EA	19.000
8161510	TRASH RECEPTACLE (OUTSIDE)	EA	2.000
8115510	Irrigation Meter	EA	1.000
8115510	Tap Fee	EA	1.000
8115510	Rain Bird ESP-16LXME Series Controller	EA	1.000
8115510	Irritrol Wireless Rain/Freeze Sensor	EA	1.000
8115510.1	Rain Bird 100-PEB Series Electric Valve	EA	7.000
8115510.1	Rain Bird #5RC Series 1" Quick-Coupling Valve	EA	2.000
8115510.1	Nibco 1" Gate Valve	EA	2.000
8115510.1	Wilkins Model 950-XL 1" Double Check Backflow Preventer	EA	1.000
8115510.1	10" NDS Pro Series Valve Box	EA	11.000
8115510.1	Jumbo NDS Pro Series Valve Box	EA	1.000
8115510.1	Rain Bird 1812 Series 12" Pop-up Sprayhead with Nozzle	EA	84.000
8115510.1	Hunter AFB Series Pressure Compensating Adjustable Bubbler	EA	30.000
8115510.1	14-1 P.E. Jacketed Control Wire	LF	3,500.000
8115510.1	1" Lateral PR-200 PVC Pipe	LF	1,620.000
8115510.2	1 1/4" Lateral PR-160 PVC Pipe	LF	80.000
8115510.2	1 1/2" Mainline PR-160 PVC Pipe	LF	420.000
8115510.2	2" Sleeve Schedule 40 PVC Pipe	LF	680.000
8115510.2	4" Sleeve Schedule 40 PVC Pipe	LF	180.000

PREPARED FOR:



I-95 BUSINESS LOOP PHASE 1B SUMMARY OF ESTIMATED QUANTITIES

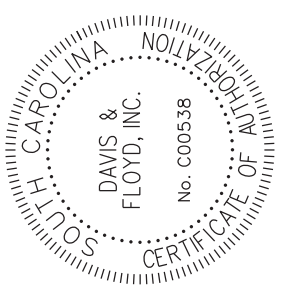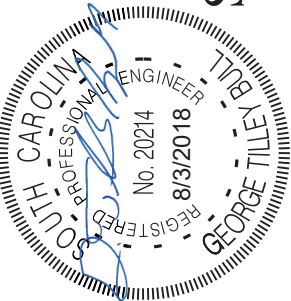Walterboro, South Carolina



DGN: LEK
RW: CHK
GTB

REVISION	DATE	BY	AMOUNT
# 1	05/28/15	AMS	

SHEET NUMBER
2

DAVIS & FLOYD
SINCE 1954

WWW.DAVISFLOYD.COM

3228 W. MONTAGUE AVENUE
COLUMBIA, SC 29816
(803) 732-2888

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FED. RD. DIV. NO.	STATE	COUNTY	PROJECT ID	PROJECT NO.	ROUTE NO.	SHEET NO.	TOTAL SHEETS
3	S.C.	COLLETON	0041932	31588.00	SC 63	5	

SOUTH JEFFERIES BLVD

GENERAL CONSTRUCTION NOTES:

THE CONTRACTOR MUST PERFORM ALL WORK IN ACCORDANCE WITH THE SOUTH CAROLINA DEPARTMENT OF TRANSPORTATION STANDARD DRAWINGS FOR ROAD CONSTRUCTION (LATEST EDITION), SCDOT STANDARD SPECIFICATIONS FOR HIGHWAY CONSTRUCTION (LATEST EDITION), SCDOT TRAFFIC SIGNAL SPECIFICATIONS, THE MUTCD, 2009 EDITION, AND THE REVISED DRAFT GUIDELINES FOR PUBLIC RIGHT-OF-WAY (PROWAG) 2005 OF THE U.S. ACCESS BOARD.

THE CONTRACTOR SHALL IMPLEMENT EROSION AND SEDIMENT CONTROL MEASURES TO PREVENT THE TRANSFER OF SUSPENDED SOLIDS AND/OR CHEMICAL SOLUTIONS OFF-SITE, AND TO PREVENT EXCESSIVE SILTATION OF EXISTING DRAINAGE PIPES, CULVERTS, AND DITCHES. THE CONTRACTOR SHALL ROUTINELY INSPECT AND MAINTAIN THESE DEVICES. SEE SHEET EC01.

THE LOCATIONS OF EXISTING UTILITIES AND STORM DRAINAGE FACILITIES SHOWN ON THE PLANS ARE PROVIDED FOR THE CONVENIENCE OF THE CONTRACTOR. THE ENGINEER ASSUMES NO RESPONSIBILITY FOR THE ACCURACY OR COMPLETENESS OF THE UTILITIES INFORMATION SHOWN ON THE DRAWINGS. IT IS THE CONTRACTOR'S RESPONSIBILITY TO VERIFY THE EXACT LOCATION OF ALL UTILITIES BEFORE CONSTRUCTION. PRIOR TO THE START OF ANY CONSTRUCTION ACTIVITY, IT SHALL BE THE CONTRACTOR'S RESPONSIBILITY TO CONFIRM THAT THE PROPER COORDINATION WITH THE VARIOUS UTILITY OWNERS HAS BEEN PERFORMED. THE CONTRACTOR SHALL COOPERATE WITH THE UTILITY DURING RELOCATION OPERATIONS.

THE LOCATION OF UTILITIES SHOWN IN THE PLANS SHOULD BE CONSIDERED APPROXIMATE ONLY. THE VERIFIED LOCATIONS/ELEVATIONS APPLY ONLY AT THE POINTS DESIGNATED BY A TEST HOLE. INTERPOLATIONS BETWEEN THESE POINTS HAVE NOT BEEN VERIFIED.

THE CONTRACTOR SHALL PROTECT ALL EXISTING STRUCTURES, STORM DRAINS, UTILITIES AND OTHER FACILITIES TO REMAIN AND SHALL REPAIR ANY DAMAGES DUE TO CONSTRUCTION ACTIVITIES AT NO ADDITIONAL COST TO THE OWNER.

THE CONTRACTOR SHALL NOT STORE ANY MATERIALS OR EQUIPMENT WITHIN 15 FT OF THE EDGE OF TRAVEL WAY.

PIPE LENGTHS THAT ARE SHOWN ON THE PLANS ARE CALCULATED ALONG THE PIPE SLOPE FROM CENTER OF BOX TO CENTER OF BOX. FIELD ADJUSTMENTS OF THE ACTUAL PIPE LENGTHS MAY BE NECESSARY.

FINAL SURFACE COURSE ON ALL ROADWAYS SHALL NOT BE PLACED UNTIL ALL DRAINAGE AND CURB AND GUTTER INSTALLATIONS ARE COMPLETE.

THE CONTRACTOR SHALL PROVIDE AND MAINTAIN PROPER DEWATERING PROCEDURES TO PREVENT THE FLOW AND ACCUMULATION OF SURFACE AND GROUND WATER IN EXCAVATED AREAS. ALL OF THE WATER PUMPED OR DRAINED SHALL BE DISPOSED OF WITHOUT UNDUE INTERFERENCE WITH OTHER WORK OR DAMAGE TO PAVEMENTS AND OTHER SURFACES OR PROPERTY. DISCHARGED WATER FROM ALL DEWATERING OPERATIONS SHALL BE FILTERED IN ACCORDANCE WITH SCDHEC REGULATIONS OR AS APPROVED BY THE ENGINEER.

THE CONTRACTOR SHALL PROVIDE A DETAILED STORM WATER POLLUTION PREVENTION PLAN TO THE RESIDENT CONSTRUCTION MANAGER FOR APPROVAL PRIOR TO COMMENCING ANY WORK ON THE PROJECT.

THE CONTRACTOR SHALL PROVIDE A DETAILED TRAFFIC CONTROL PLAN TO THE RESIDENT CONSTRUCTION MANAGER FOR APPROVAL BEFORE STARTING ANY WORK ON THE PROJECT. THIS PLAN SHALL INCLUDE DETAILS CONCERNING PLACEMENT OF REFLECTORIZED BARRELS, CONES, AND/OR TYPE 2 BARRICADES IN ACCORDANCE WITH THE 2009 MUTCD. THE PLAN SHALL ALSO INCLUDE DETAILS TO MAINTAIN PEDESTRIAN MOBILITY DURING CONSTRUCTION WITH NECESSARY SIGNAGE IN ACCORDANCE WITH THE SOUTH CAROLINA DEPARTMENT OF TRANSPORTATION STANDARD DRAWINGS FOR ROAD CONSTRUCTION (LATEST EDITION).

THE CONTRACTOR SHALL PRESERVE AND PROTECT FROM INJURY ALL TREES NOT INDICATED TO BE REMOVED. PRUNE AND PAINT ALL TREES DAMAGED IN A SATISFACTORY MANNER AS APPROVED BY THE ENGINEER. REASONABLE CARE SHALL BE TAKEN DURING CONSTRUCTION TO AVOID DAMAGE TO VEGETATION. ORNAMENTAL SHRUBBERY AND TREE BRANCHES SHALL BE TIED BACK, WHERE APPROPRIATE, TO MINIMIZE DAMAGE. TREES WHICH RECEIVE DAMAGE TO BRANCHES SHALL BE TRIMMED OF THOSE BRANCHES TO IMPROVE THE APPEARANCE OF THE TREE. TREE TRUNKS RECEIVING DAMAGE FROM EQUIPMENT SHALL BE TREATED WITH A TREE DRESSING. ALL TREE DRESSING AND REPAIRS SHALL BE PERFORMED BY OR UNDER THE DIRECT SUPERVISION OF A TREE ARBORIST.

THE CONTRACTOR SHALL PROVIDE ALL SHEETING, SHORING, AND BRACING REQUIRED TO PROTECT ADJACENT STRUCTURES AND UTILITIES OR TO MINIMIZE TRENCH WIDTH AS REQUIRED. PAYMENT FOR SUCH MEASURES IS INCLUDED IN THE BID PRICE FOR THE ITEM BEING CONSTRUCTED.

WHERE STORM PIPES AND STRUCTURES ARE IDENTIFIED TO BE ABANDONED IN PLACE, THE FOLLOWING PROCEDURES SHALL BE UTILIZED:

- PIPES: PLUG END(S) WITH BRICK AND GROUT.
- STRUCTURES: REMOVE RIM/COVER AND CONE OR TOP SLAB.
- PLUG PIPE OPENINGS WITH BRICK AND GROUT.
- FILL STRUCTURE WITH FLOWABLE FILL TO BOTTOM OF PAVEMENT SECTION.
- TEMPORARY ASPHALT IF NEEDED.

THE CONTRACTOR SHALL REVIEW AND VERIFY ALL DIMENSIONS SHOWN ON THE PLANS AND REVIEW ALL FIELD CONDITIONS THAT MAY AFFECT CONSTRUCTION. SHOULD DISCREPANCIES OCCUR, THE CONTRACTOR SHALL NOTIFY THE ENGINEER TO OBTAIN THE ENGINEER'S CLARIFICATION BEFORE COMMENCING CONSTRUCTION.

THE ENGINEER RESERVES THE RIGHT TO ADJUST THE LOCATION OF ALL PROPOSED IMPROVEMENTS TO MEET FIELD CONDITIONS IF NECESSARY.

THE FOLLOWING QUANTITIES ARE NOT SHOWN IN DETAIL ON THE PLANS BUT ARE INCLUDED IN THE SUMMARY OF ESTIMATED QUANTITIES AND MAY BE ADJUSTED DURING CONSTRUCTION AS DIRECTED BY THE ENGINEER.

INCLUSION ITEMS

INCLUSION ITEMS			
DESCRIPTION	UNIT	QUANTITY	DESCRIPTION
MOBILIZATION	LS	NEC	PER CONTRACT DOCUMENTS
BONDS AND INSURANCE	LS	1	PER CONTRACT DOCUMENTS
CONSTRUCTION STAKES, LINES & GRADES	EA	1	PER CONTRACT DOCUMENTS
CPM PROGRESS SCHEDULE	LS	NEC	PER CONTRACT DOCUMENTS
REMOVAL & DISPOSAL OF EXISTING PAVEMENT	SY	50	WHERE DIRECTED BY ENGINEER
MAINTENANCE STONE	TON	50	FOR TEMPORARY DRIVEWAYS
CONCRETE CURB AND GUTTER(2'-0") VERTICAL FACE	LF	27.000	WHERE DIRECTED BY ENGINEER
CONCRETE SIDEWALK(4" UNIFORM) OYSTER SHELL FINISH	SY	250.000	WHERE DIRECTED BY ENGINEER
CONCRETE DRIVEWAY (6" UNIFORM) OYSTER SHELL FINISH	SY	110.000	WHERE DIRECTED BY ENGINEER
SILT FENCE	LF	100.000	WHERE DIRECTED BY ENGINEER
U-SECTION POST FOR SIGN SUPPORTS - 3P	LF	44	WHERE DIRECTED BY ENGINEER
SODDING	SY	200	WHERE DIRECTED BY ENGINEER

SCDOT STANDARD DRAWING DETAILS

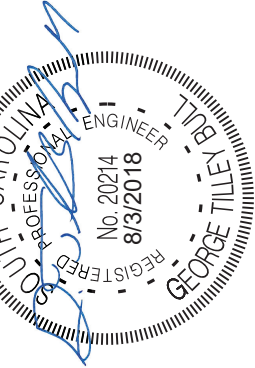
- SEE SCDOT STANDARD DRAWING NO. 605-010-02 FOR PERMANENT CONSTRUCTION SIGNS DETAILS.
- SEE SCDOT STANDARD DRAWING NO. 625-305-00 AND 625-410-00 FOR PAVEMENT MARKING DETAILS.
- SEE SCDOT STANDARD DRAWING NO. 650-110-02 FOR SIGN INSTALLATION DETAILS.
- SEE SCDOT STANDARD DRAWING NO. 720-105-01 AND 720-105-02 FOR CURB AND GUTTER DETAILS.
- SEE SCDOT STANDARD DRAWING NO. 720-405-00 FOR CONCRETE DRIVEWAY DETAILS.
- SEE SCDOT STANDARD DRAWING NO. 720-901-01, 720-901-02, 720-901-03 AND 720-929-01 FOR PEDESTRIAN RAMP DETAILS.
- SEE SCDOT STANDARD DRAWING NO. 675-105-03, 675-110-00, 675-115-03, 675-120-00, 675-130-01 AND 675-130-03 FOR SIGNAL DETAILS.
- SEE SCDOT STANDARD DRAWING NO. 809-105-00 FOR RIGHT-OF-WAY PLAT & REBAR CAP MARKER DETAILS.

PREPARED FOR:



CITY OF WALTERBORO
100 W. MAIN STREET
WALTERBORO, SOUTH CAROLINA 29488

**I-95 BUSINESS LOOP
PHASE 1B
GENERAL CONSTRUCTION NOTES**
Walterboro, South Carolina



DGN: LEK
RW: GTB
CHK: GTB

#	REVISION	DATE	BY

DAVIS & FLOYD
SINCE 1954

3329 W. MONTAGUE AVENUE
COLUMBIA, SC 29405
803.733.2948

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NTS

SHEET NUMBER
5

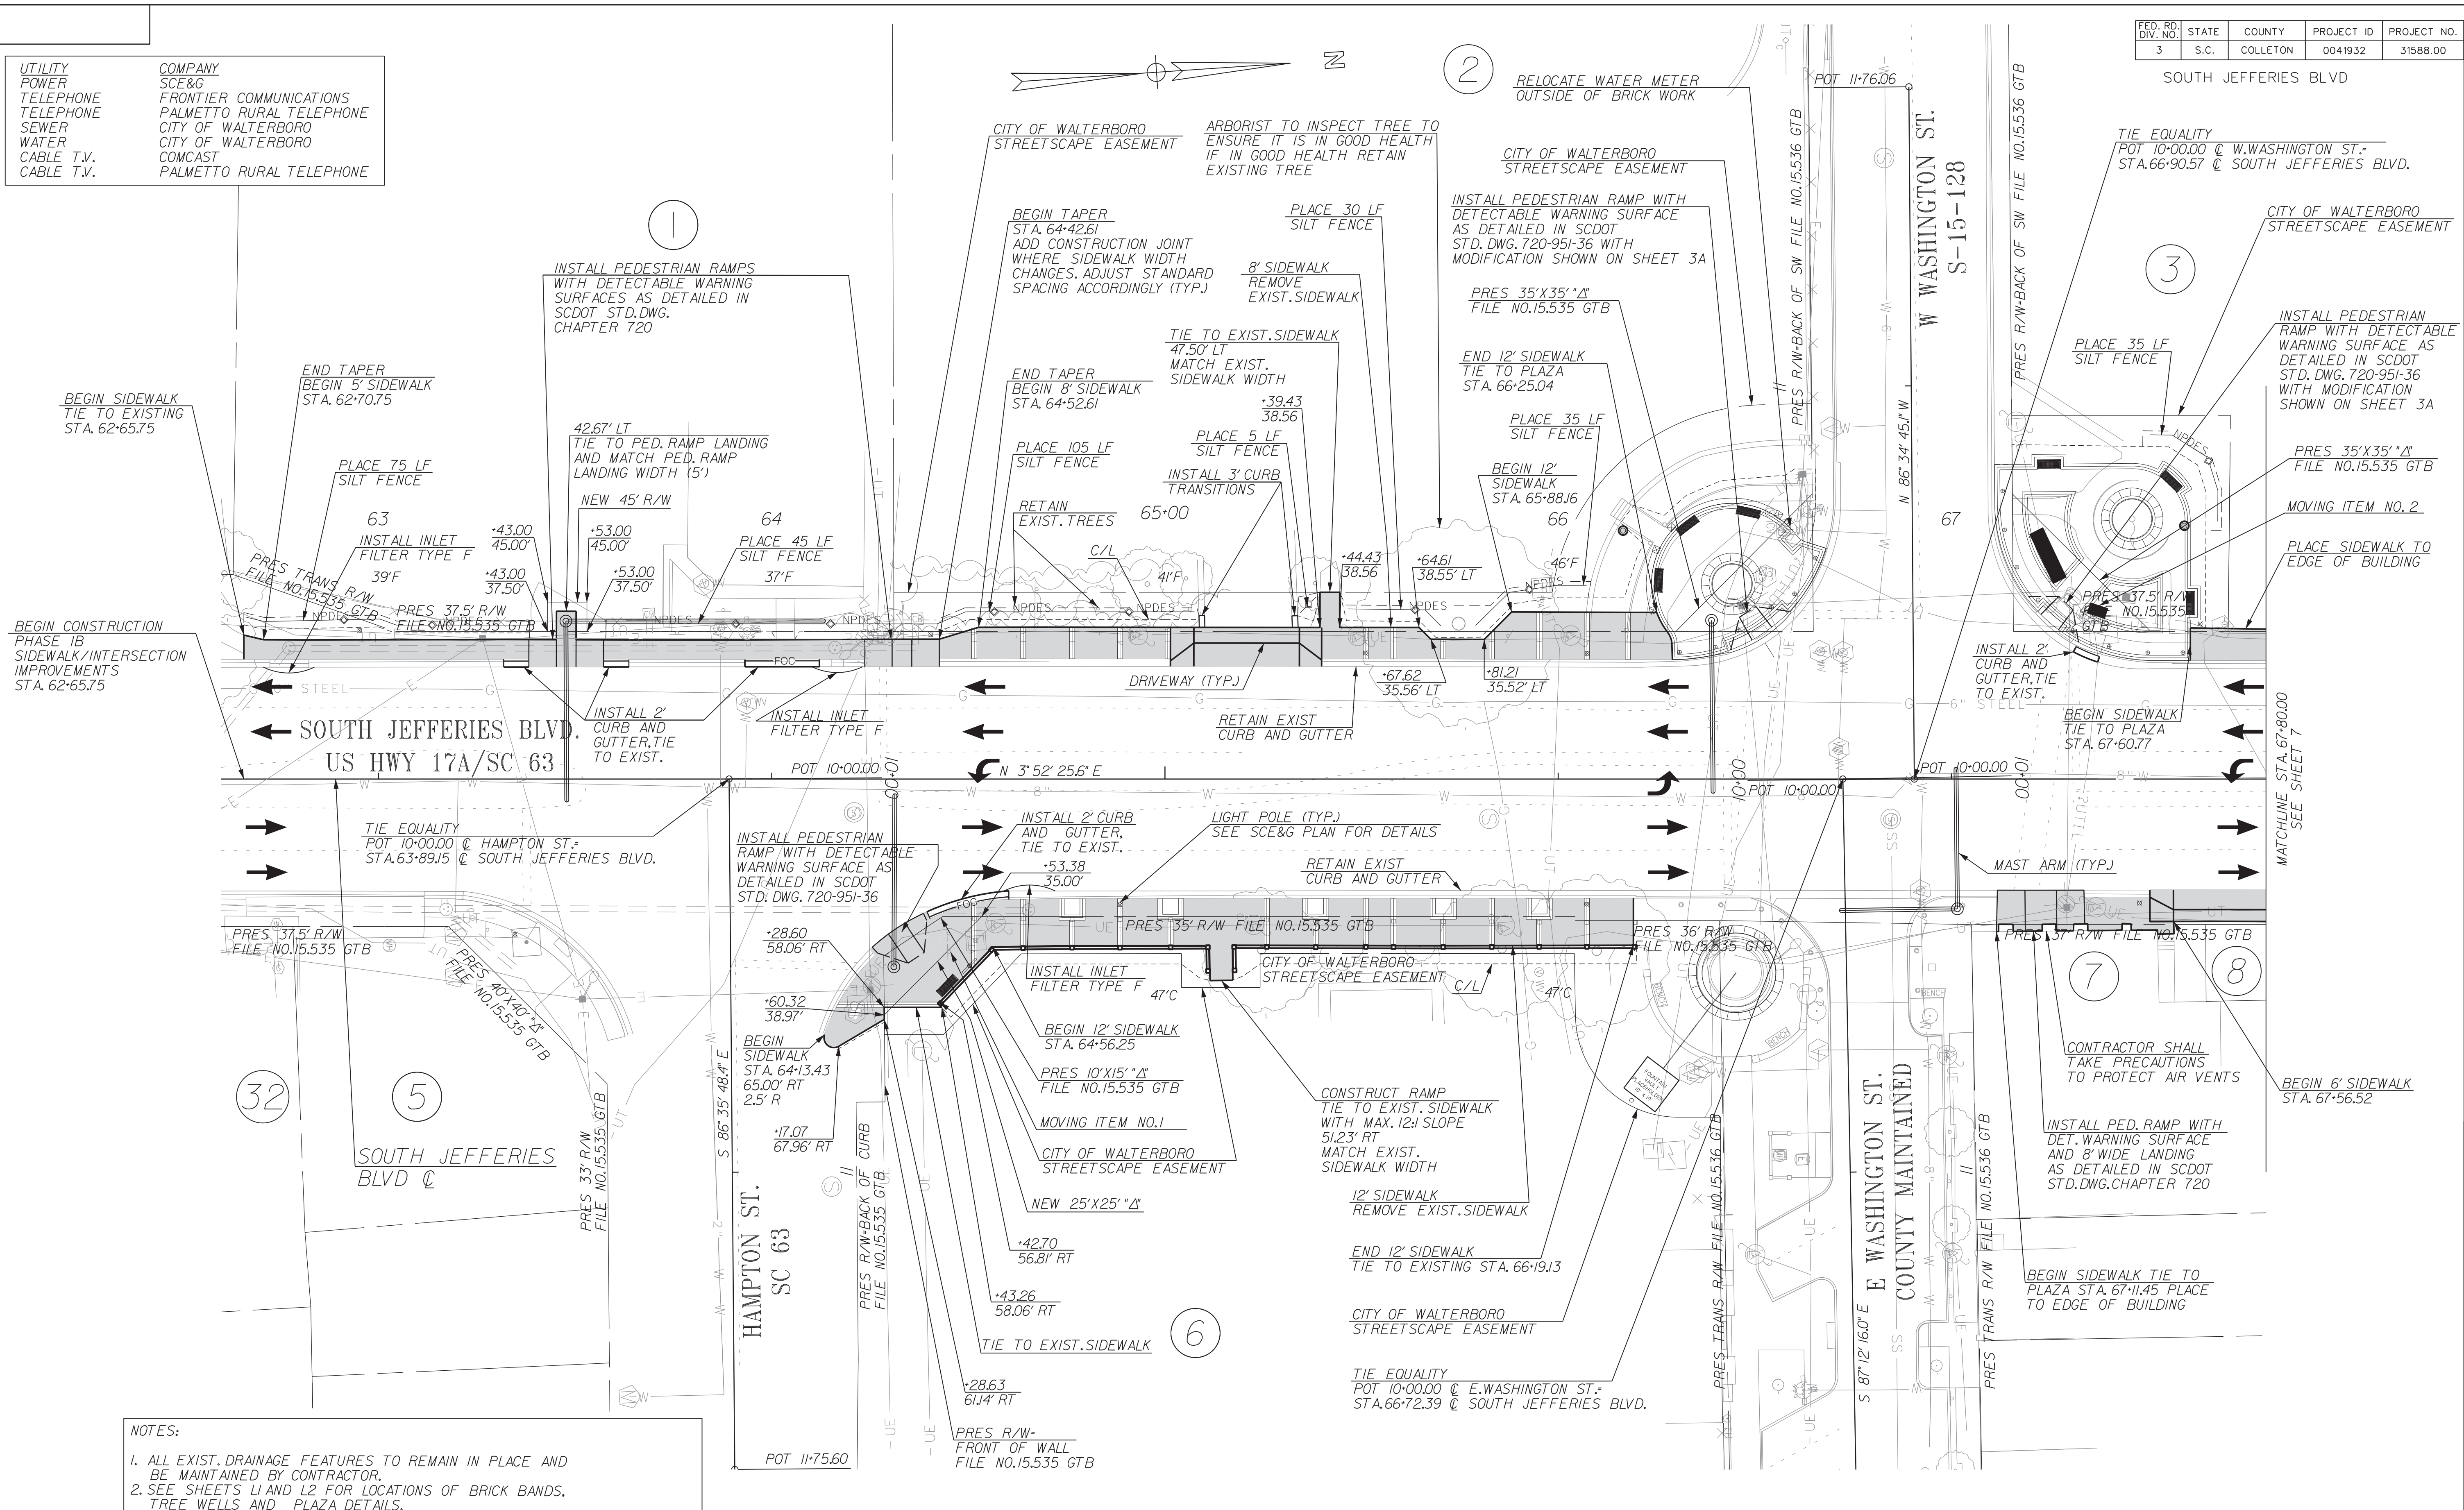
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FILE NAME: \\CHS-FS\DATA\Jobs\Even\31588-00\CV_dgn\Insite\Phase 1B (IB1)Federat\3158800-IB1-05-gcn.dgn

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FED. RD. DIV. NO.	STATE	COUNTY	PROJECT ID	PROJECT NO.	ROUTE NO.	SHEET NO.	TOTAL SHEETS
3	S.C.	COLLETON	0041932	31588.00	SC 63	6	

UTILITY	COMPANY
POWER	SCE&G
TELEPHONE	FRONTIER COMMUNICATIONS
TELEPHONE	PALMETTO RURAL TELEPHONE
SEWER	CITY OF WALTERBORO
WATER	CITY OF WALTERBORO
CABLE T.V.	COMCAST
CABLE T.V.	PALMETTO RURAL TELEPHONE



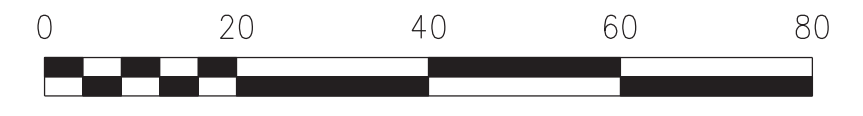
- NOTES:**
- ALL EXIST. DRAINAGE FEATURES TO REMAIN IN PLACE AND BE MAINTAINED BY CONTRACTOR.
 - SEE SHEETS L1 AND L2 FOR LOCATIONS OF BRICK BANDS, TREE WELLS AND PLAZA DETAILS.
 - SEE SHEETS S1 AND S2 FOR WALL DETAILS AND UNDERDRAIN LOCATION. TIE UNDERDRAIN TO EXISTING CATCH BASIN AT STA. 64+65.
 - CONTRACTOR SHALL COORDINATE WITH SCE&G FOR LIGHTING INSTALLATION. FOR LIGHTS INSTALLED WITHIN THE SIDEWALK BEHIND CURB AND GUTTER, THERE SHALL BE A MINIMUM OF 6' BETWEEN THE LIGHT POLE AND BACK OF SIDEWALK. SEE DETAIL ON SHEET 3A.
 - CONTRACTOR IS RESPONSIBLE FOR TAP FEES AND CONNECTING FOUNTAIN TO POTABLE, SANITARY AND ELECTRIC. SEE SHEETS L7, L8 AND L20-L30 FOR FOUNTAIN DETAILS.

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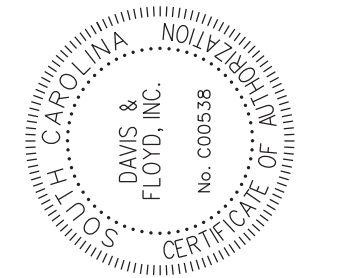
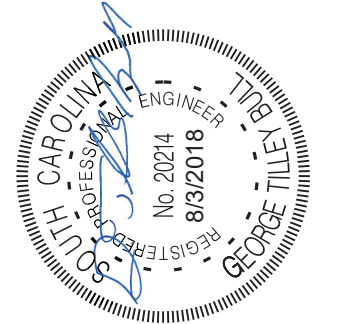


SCALE: 1"=20'



**I-95 BUSINESS LOOP
PHASE 1B
PLAN SHEET**

Walterboro, South Carolina



DGN: LEK
R/W: CHK: GTB



REVISION	DATE	BY

SHEET NUMBER
6

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FED. RD. DIV. NO.	STATE	COUNTY	PROJECT ID	PROJECT NO.	ROUTE NO.	SHEET NO.	TOTAL SHEETS
3	S.C.	COLLETON	0041932	31588.00	SC 63	7	

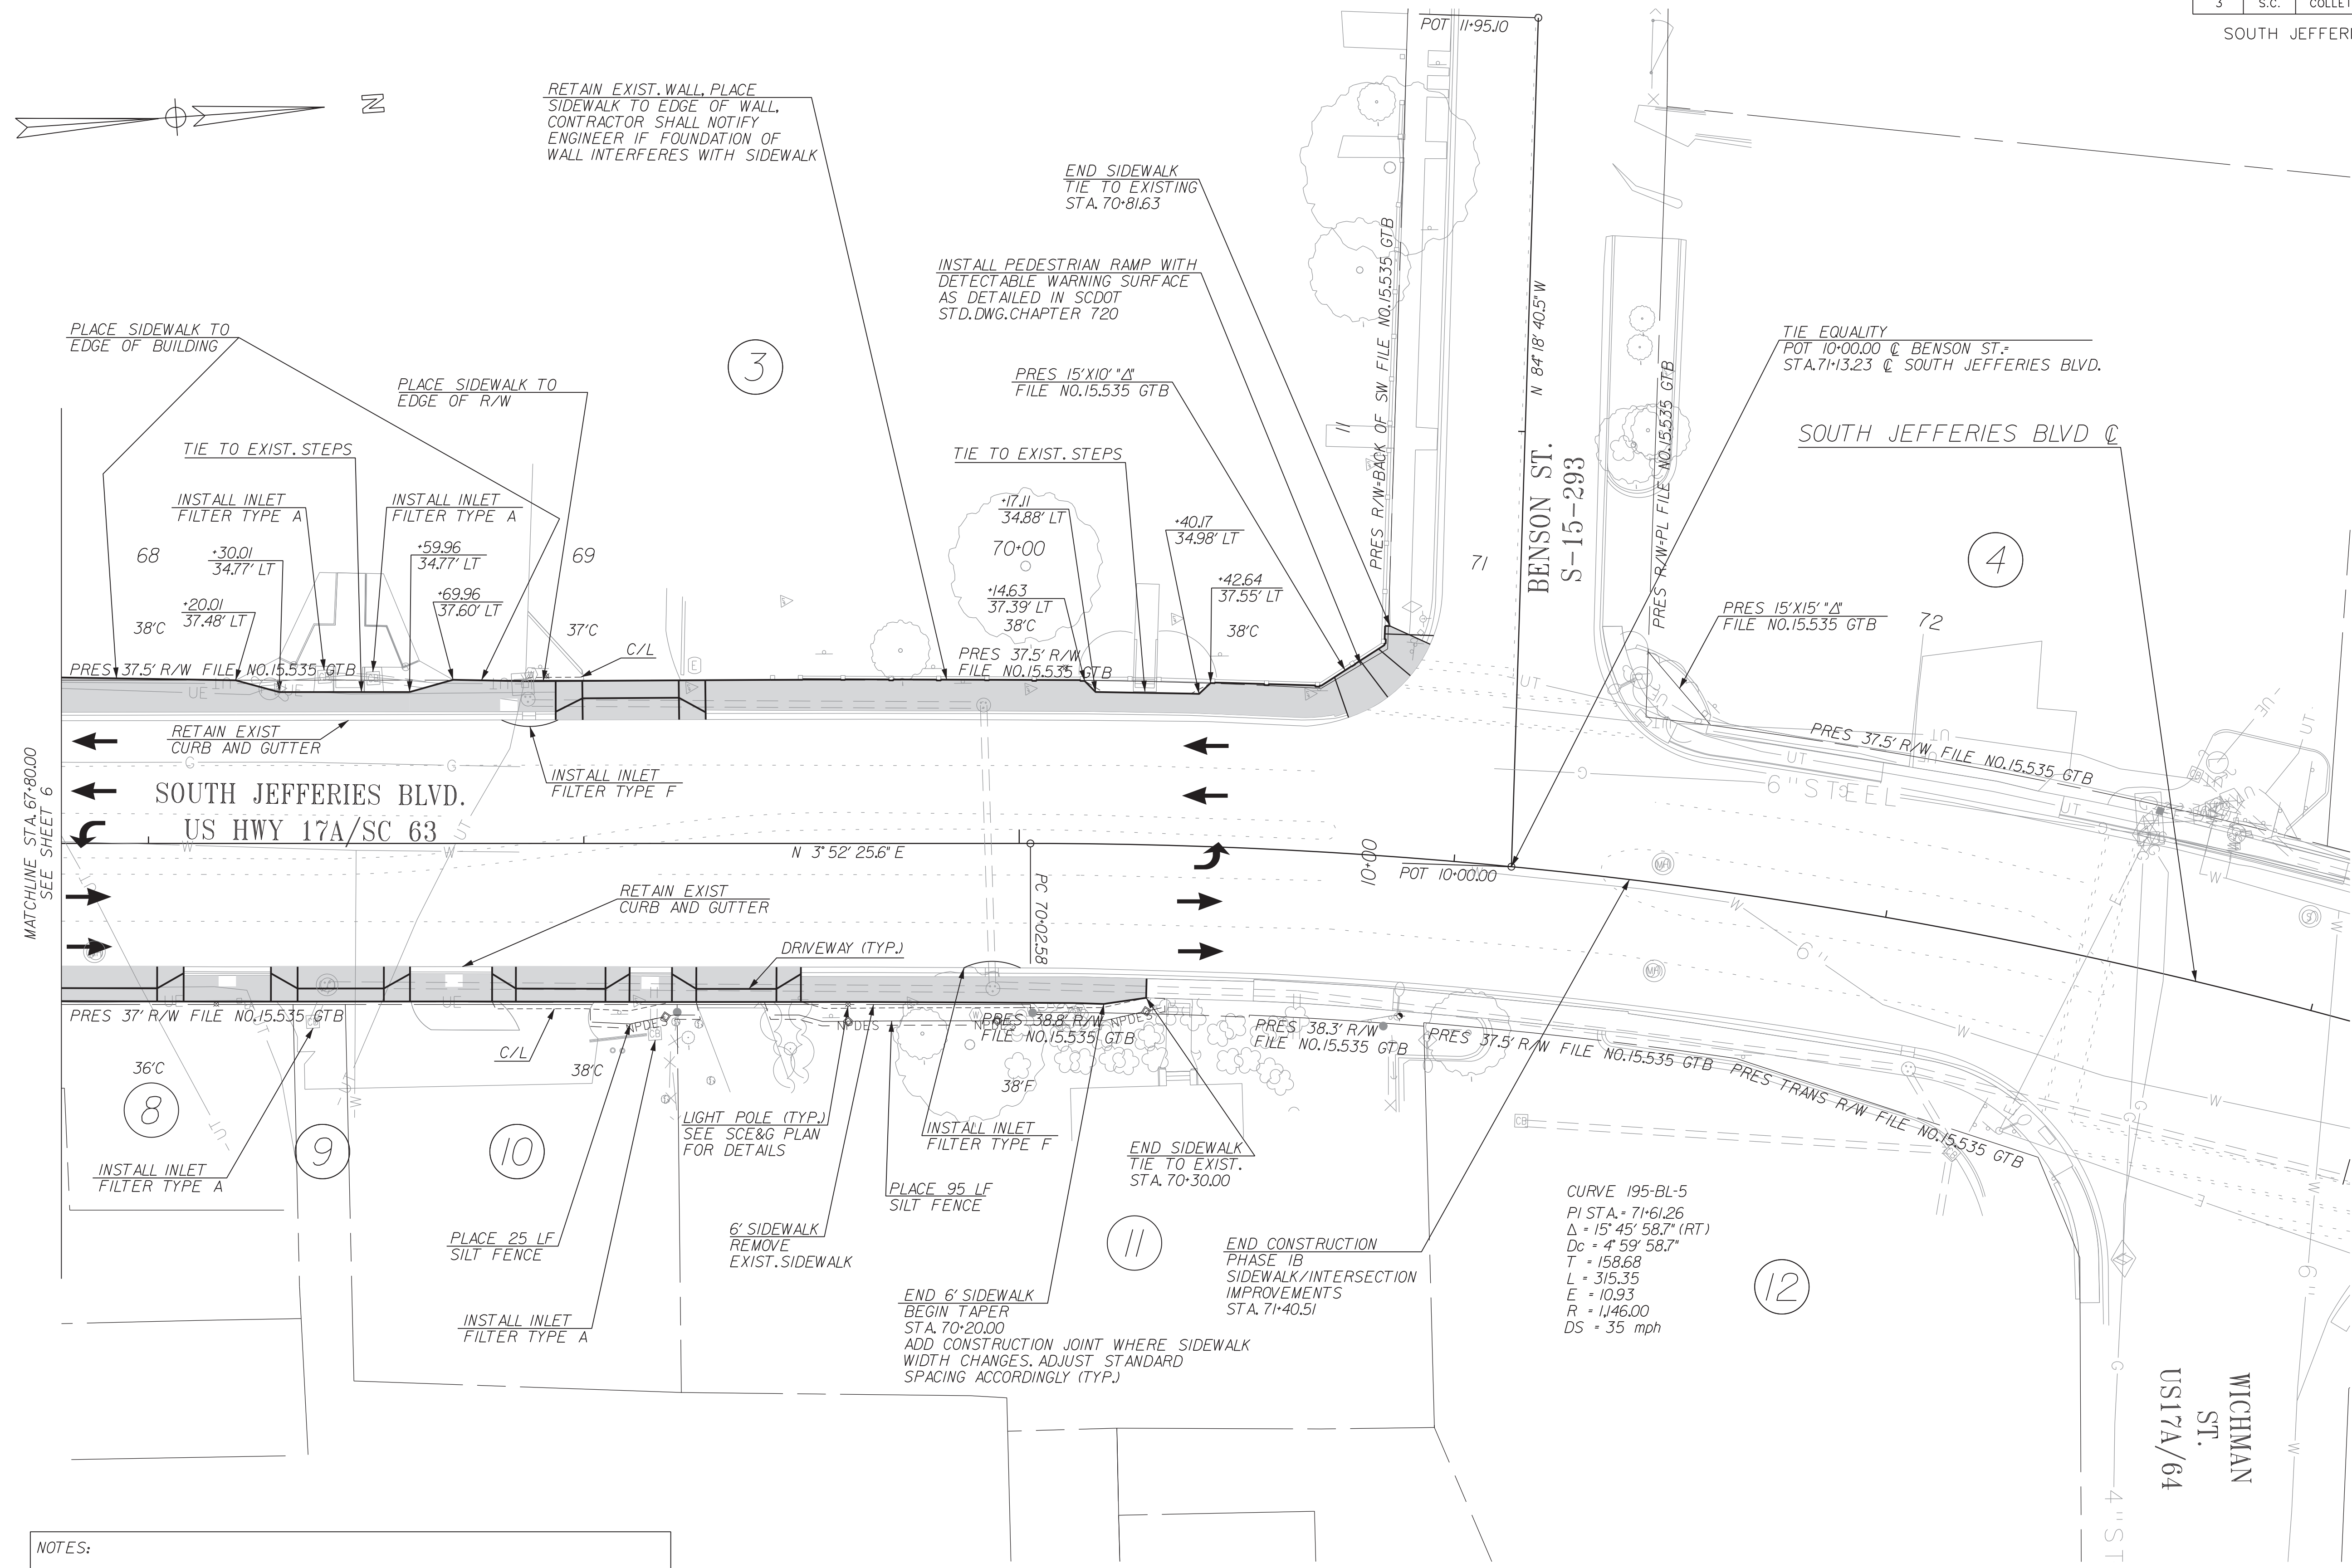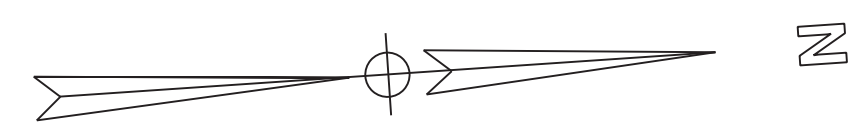SOUTH JEFFERIES BLVD



NOTES:

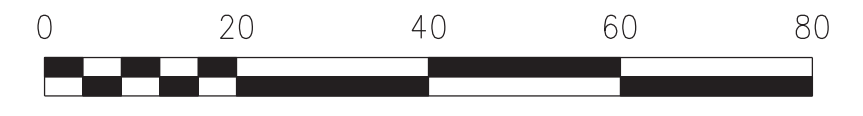
1. ALL EXIST. DRAINAGE FEATURES TO REMAIN IN PLACE AND BE MAINTAINED BY CONTRACTOR.
2. SEE SHEETS L1 AND L2 FOR LOCATIONS OF BRICK BANDS, TREE WELLS AND PLAZA DETAILS.
3. CONTRACTOR SHALL COORDINATE WITH SCE&G FOR LIGHTING INSTALLATION. FOR LIGHTS INSTALLED WITHIN THE SIDEWALK BEHIND CURB AND GUTTER, THERE SHALL BE A MINIMUM OF 6' BETWEEN THE LIGHT POLE AND BACK OF SIDEWALK. SEE DETAIL ON SHEET 3A.

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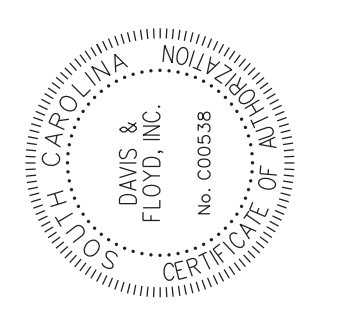
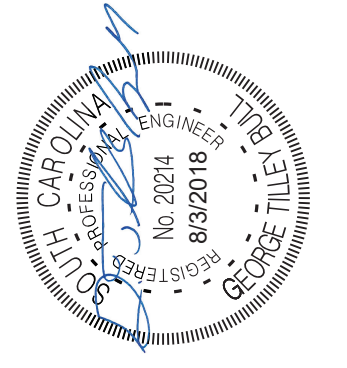
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Land Planners



SCALE: 1" = 20'



**I-95 BUSINESS LOOP
PHASE 1B
PLAN SHEET**
Walterboro, South Carolina




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R/W: CHK: GTB

REVISION	DATE	BY


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FED. DIST. NO.	STATE	COUNTY	PROJECT ID	PROJECT NO.	ROUTE NO.	SHEET NO.	TOTAL SHEETS
3	S.C.	COLLETON	0041932	02-14011	SC 63		


PREPARED FOR:

 CITY OF WALTERBORO
 242 HAMPTON STREET
 WALTERBORO, SOUTH CAROLINA 29688

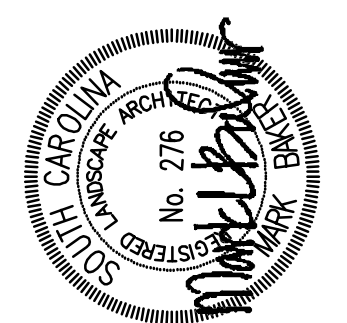I-95 BUSINESS LOOP PHASES 1B
 Walterboro, South Carolina




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 RW: CJ
 CHK: MB

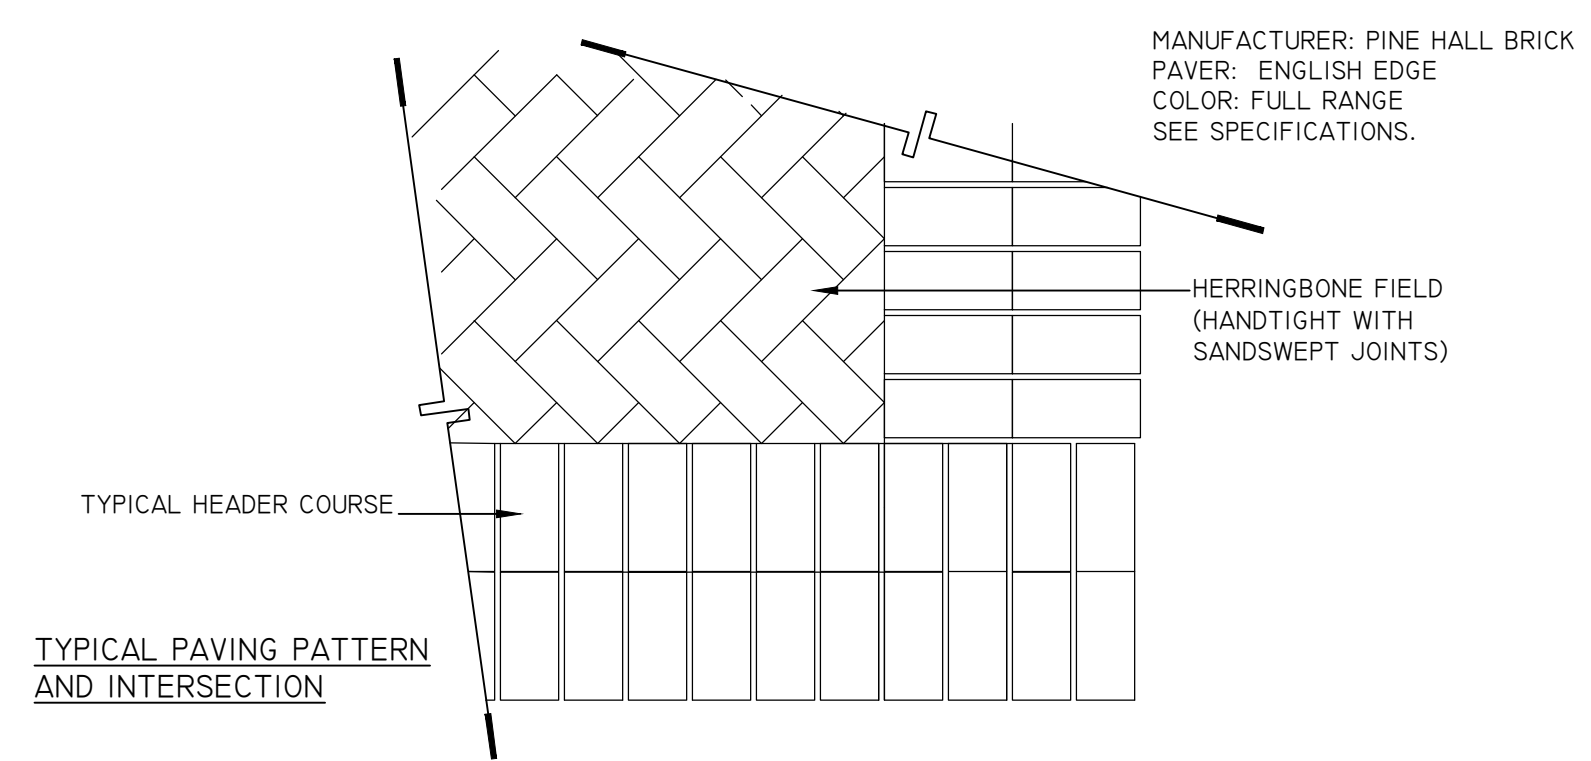
REVISION	#	DATE	BY



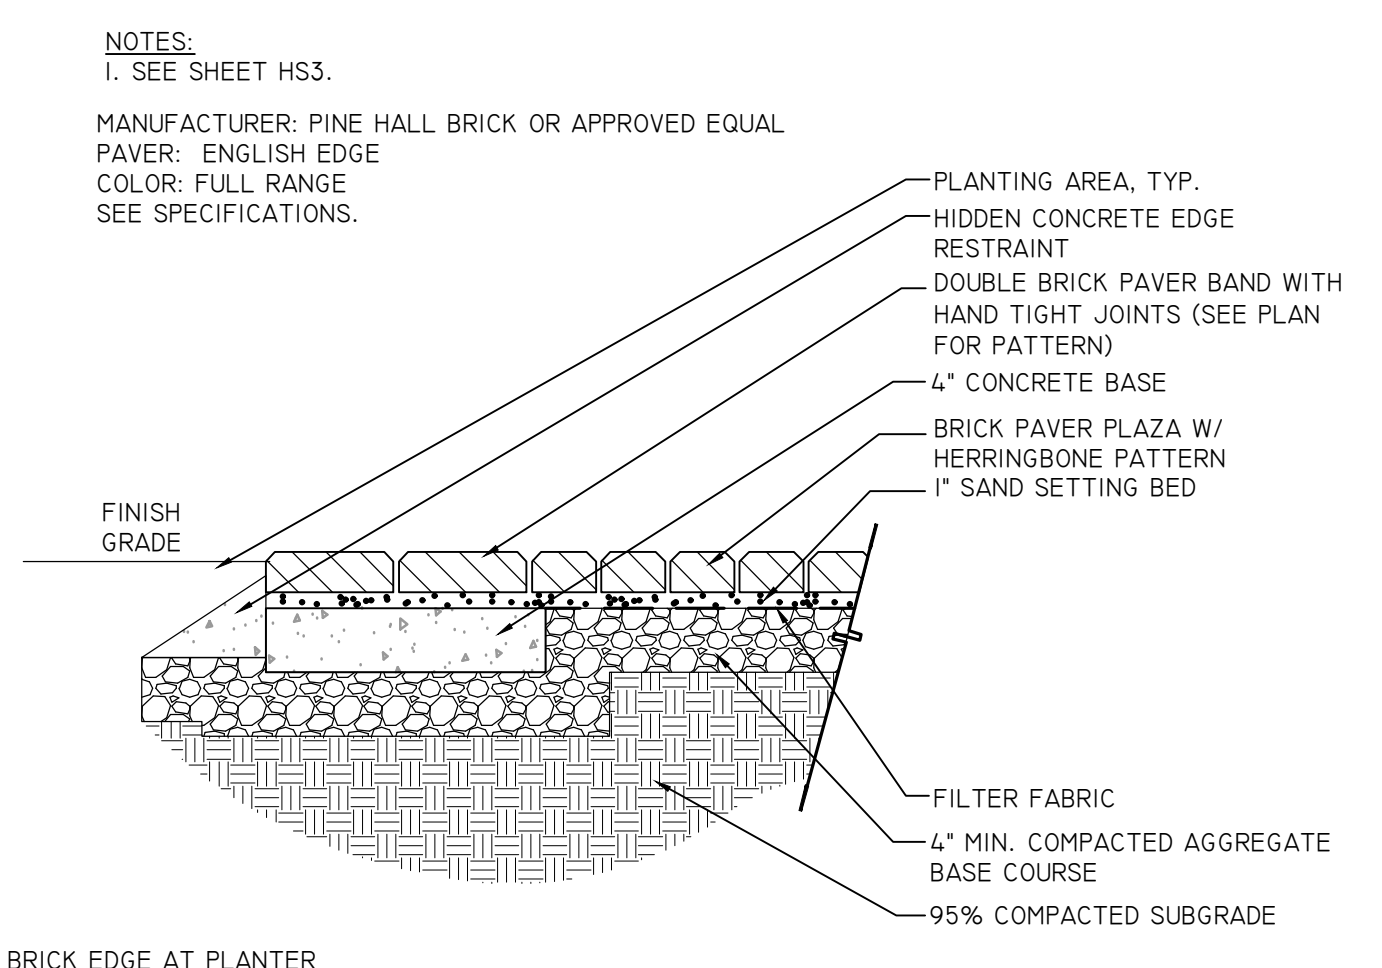
1 ADA FLUSH CURB AT PEDESTRIAN PLAZAS
 SCALE: 3/8" = 1'-0"



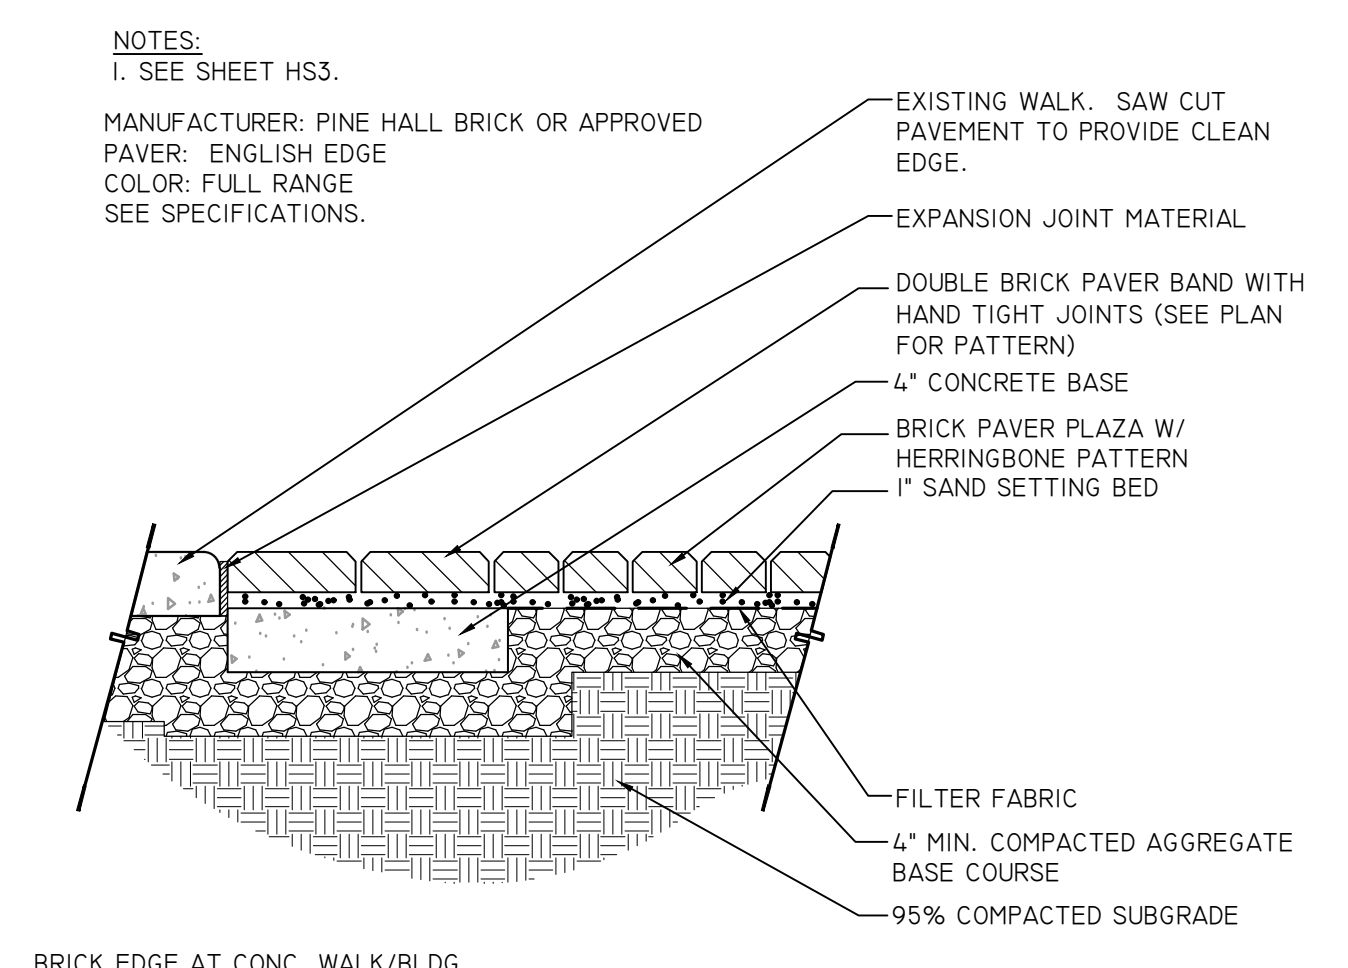
2 PEDESTRIAN PLAZA PAVERS
 SCALE: 3/4" = 1'-0"



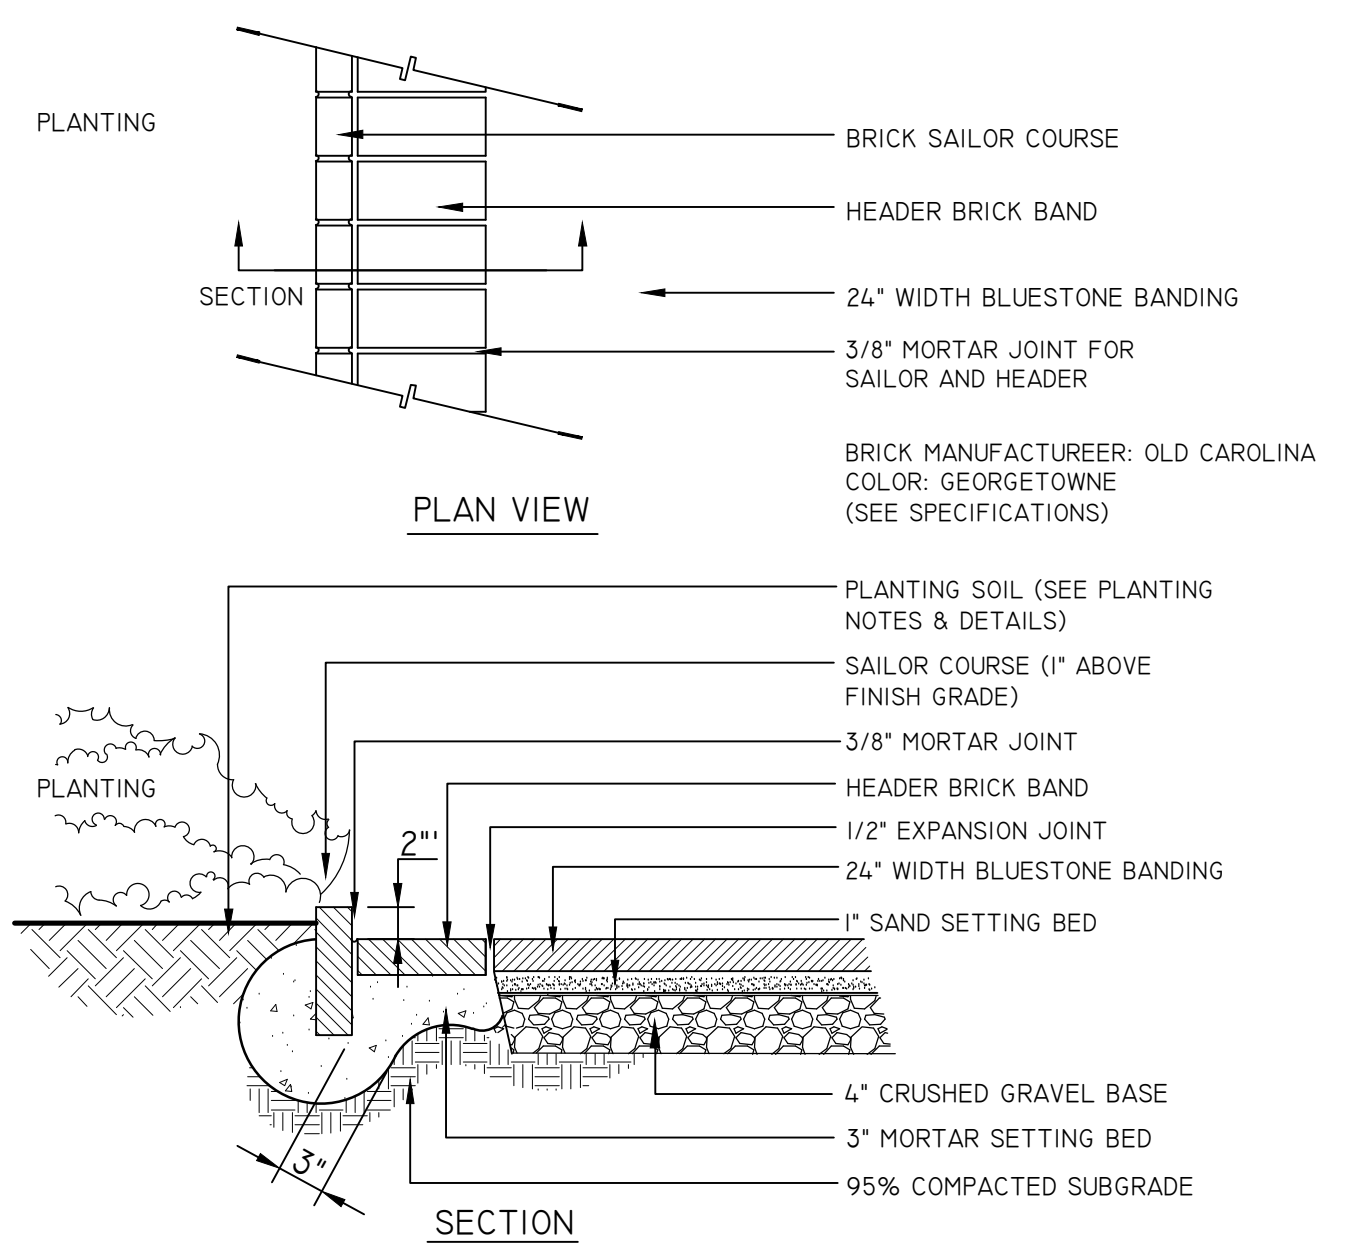2 PEDESTRIAN PLAZA PAVERS
 SCALE: 3/4" = 1'-0"



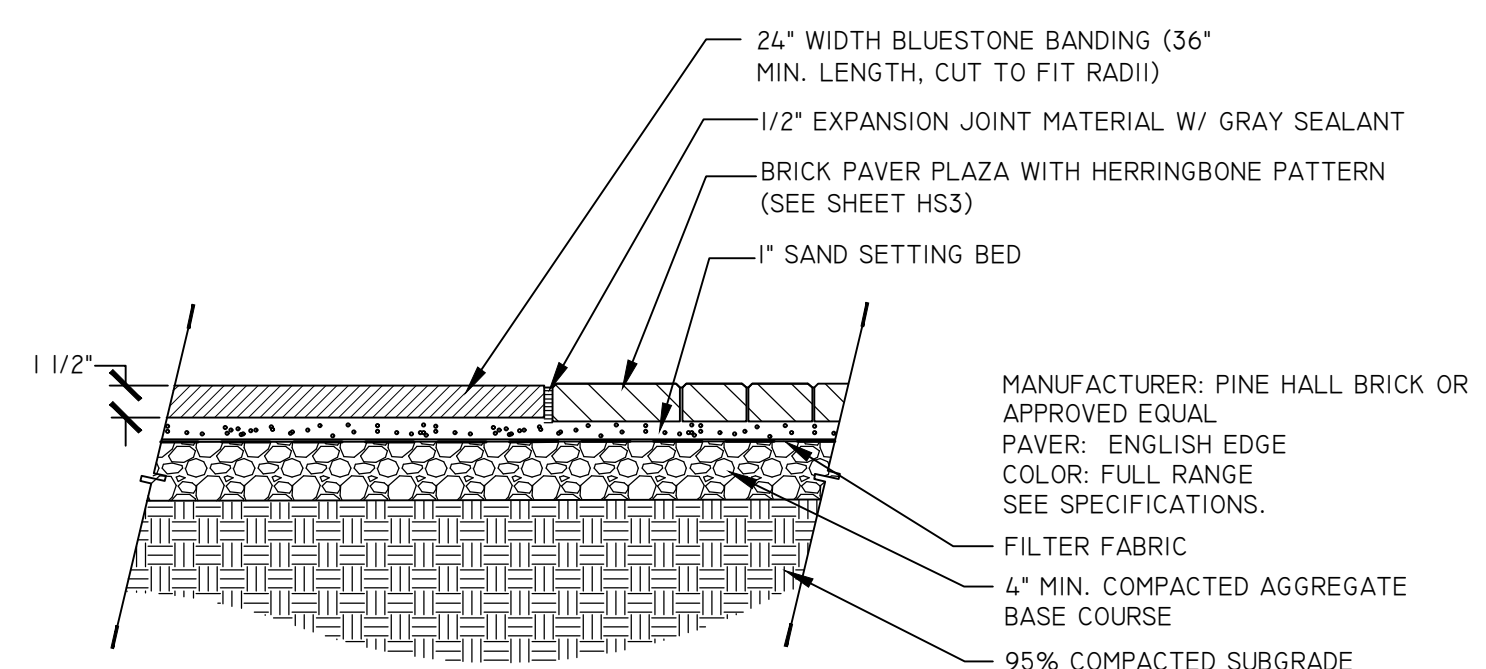3 BRICK LANDSCAPE CURB
 SCALE: 1" = 1'-0"



4 BLUESTONE PAVING IN PEDESTRIAN PLAZAS
 SCALE: 3/4" = 1'-0"

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 Call 811. Before you dig.

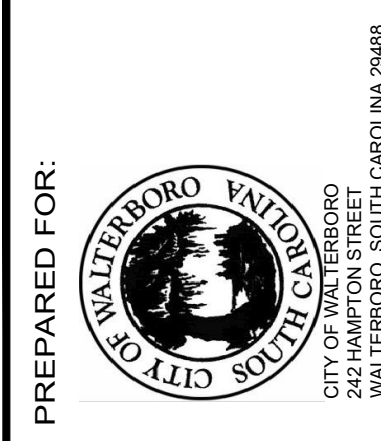
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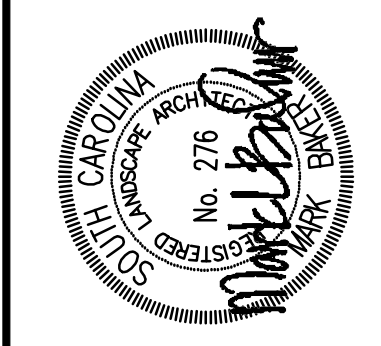
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L4

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FED. DIST. NO.	STATE	COUNTY	PROJECT ID	PROJECT NO.	ROUTE NO.	SHEET NO.	TOTAL SHEETS
3	S.C.	COLLETON	0041932	02-14011	SC 63		




I-95 BUSINESS LOOP PHASES 1B
Walterboro, South Carolina




DGN: BHKH
RW: CJ
CHK: MB

REVISION	DATE	BY

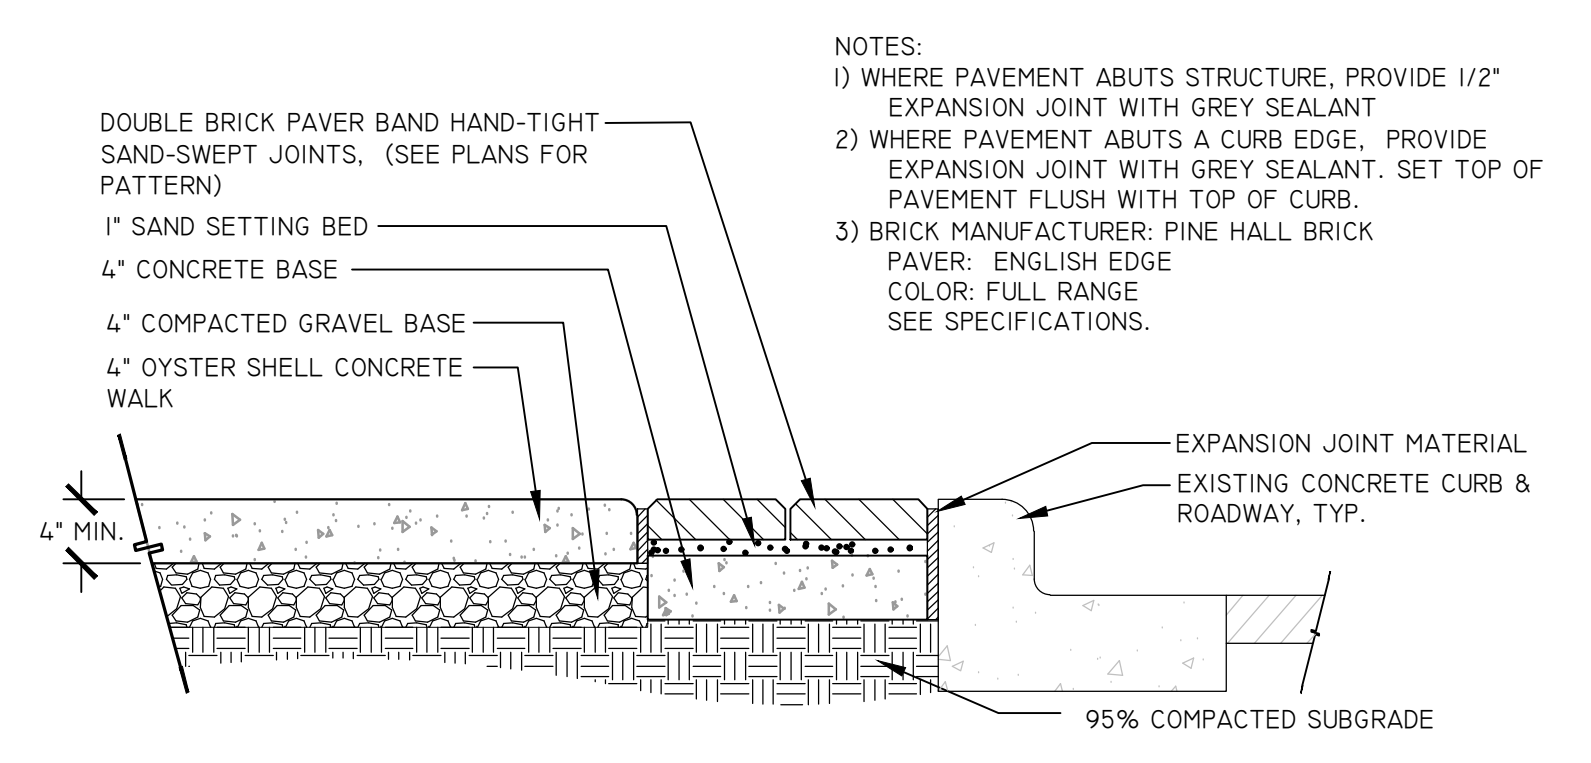
SHEET NUMBER
L5



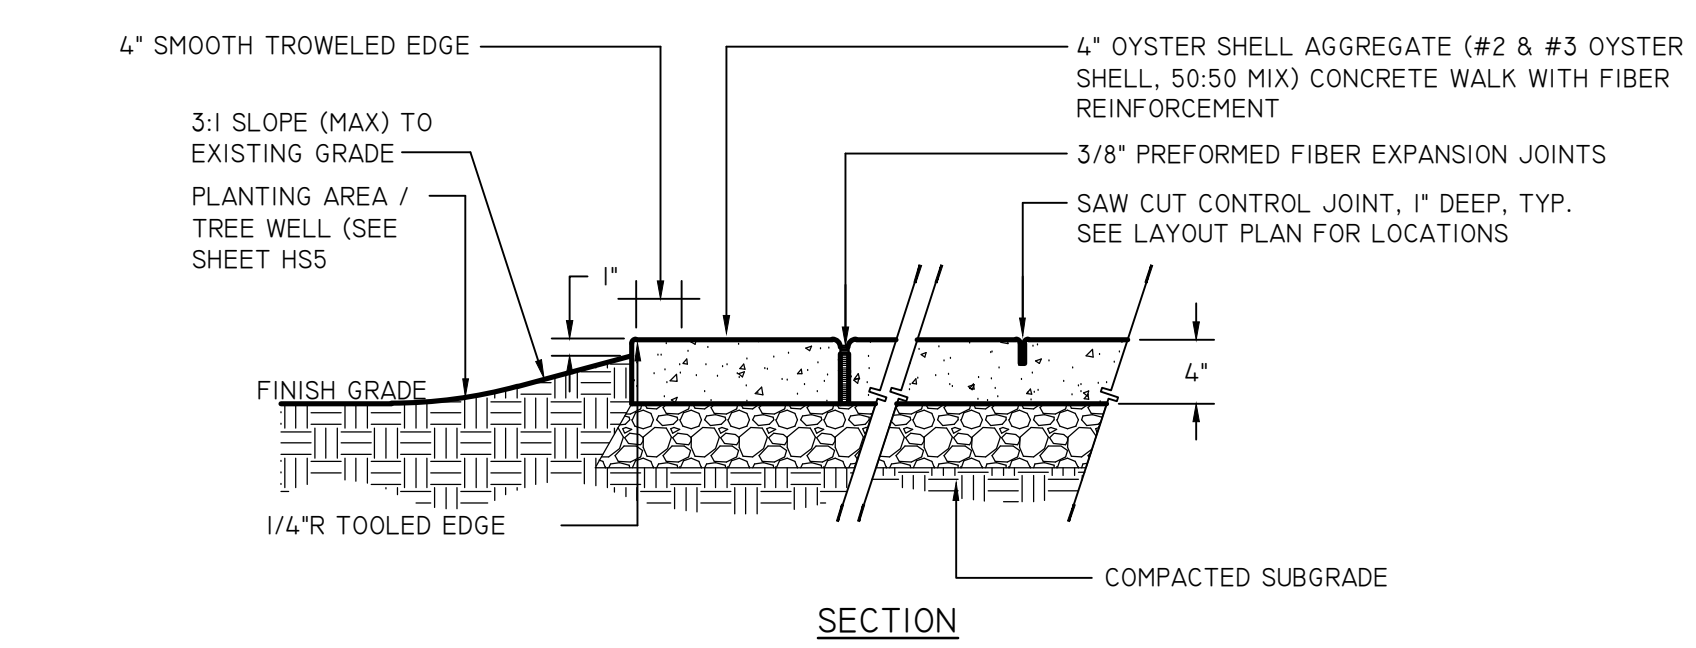3
L5
BRICK ACCENT BANDING
SCALE: 1" = 1'-0"



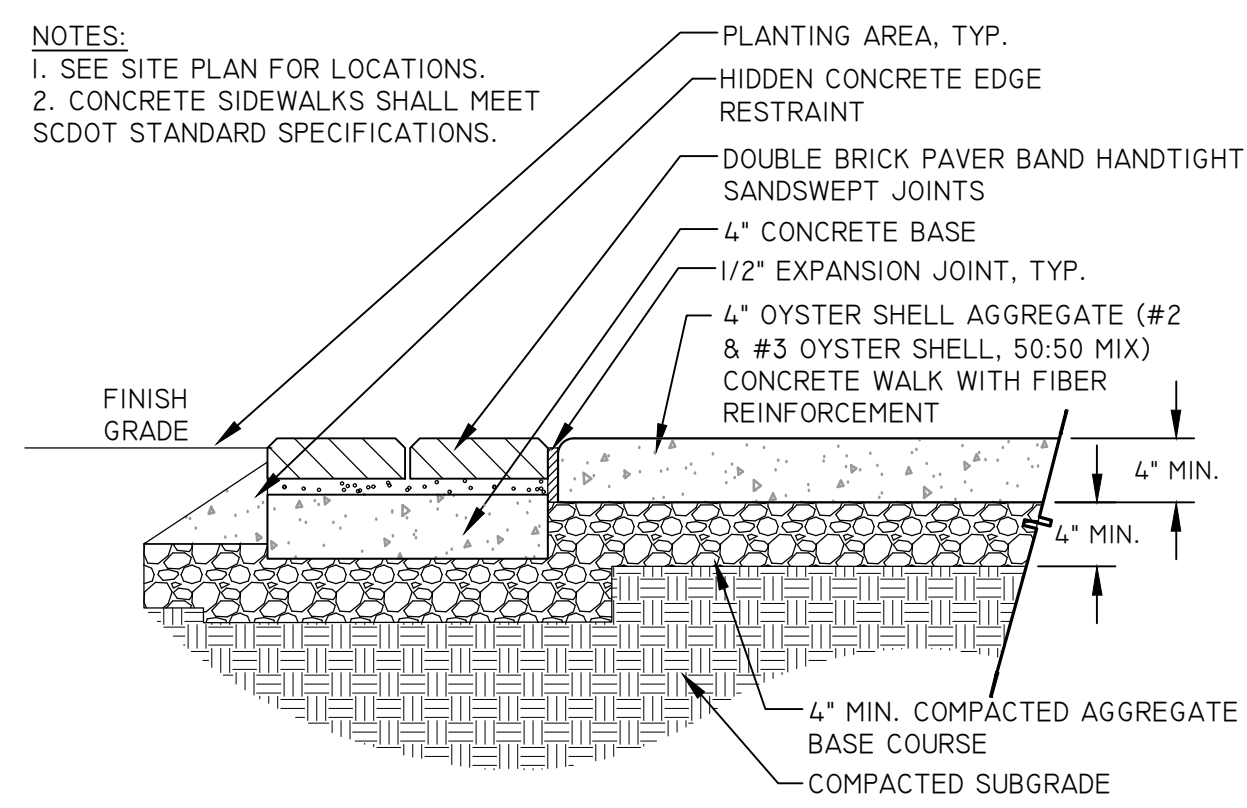
4
L5
OYSTER SHELL CONCRETE WALK
SCALE: 1" = 1'-0"




B-B' - PAVEMENT HEADER BAND AT PLANTING AREA
SCALE: 1" = 1'-0"




SAMPLE IMAGE OF OYSTER SHELL CONCRETE WITH SOLDIER COURSE BRICK PAVERS (NOT TO SCALE)
NOTE: CONTRACTOR SHALL SUBMIT OYSTER SHELL CONCRETE MIX QUALITY SAMPLE TO OWNER FOR APPROVAL PRIOR TO CONSTRUCTION.

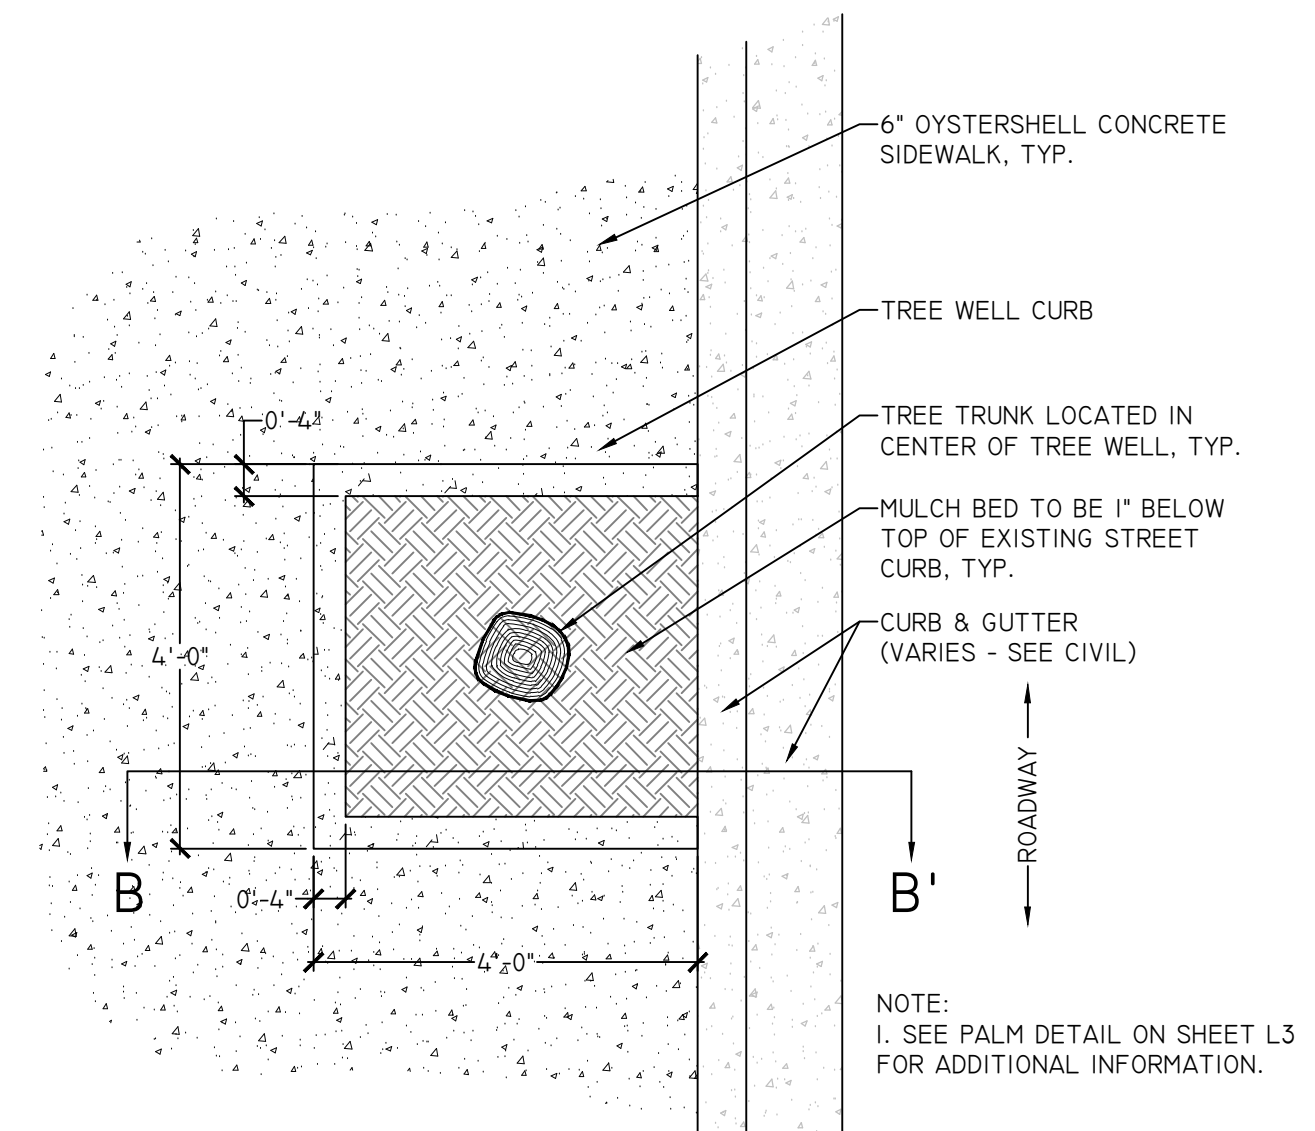

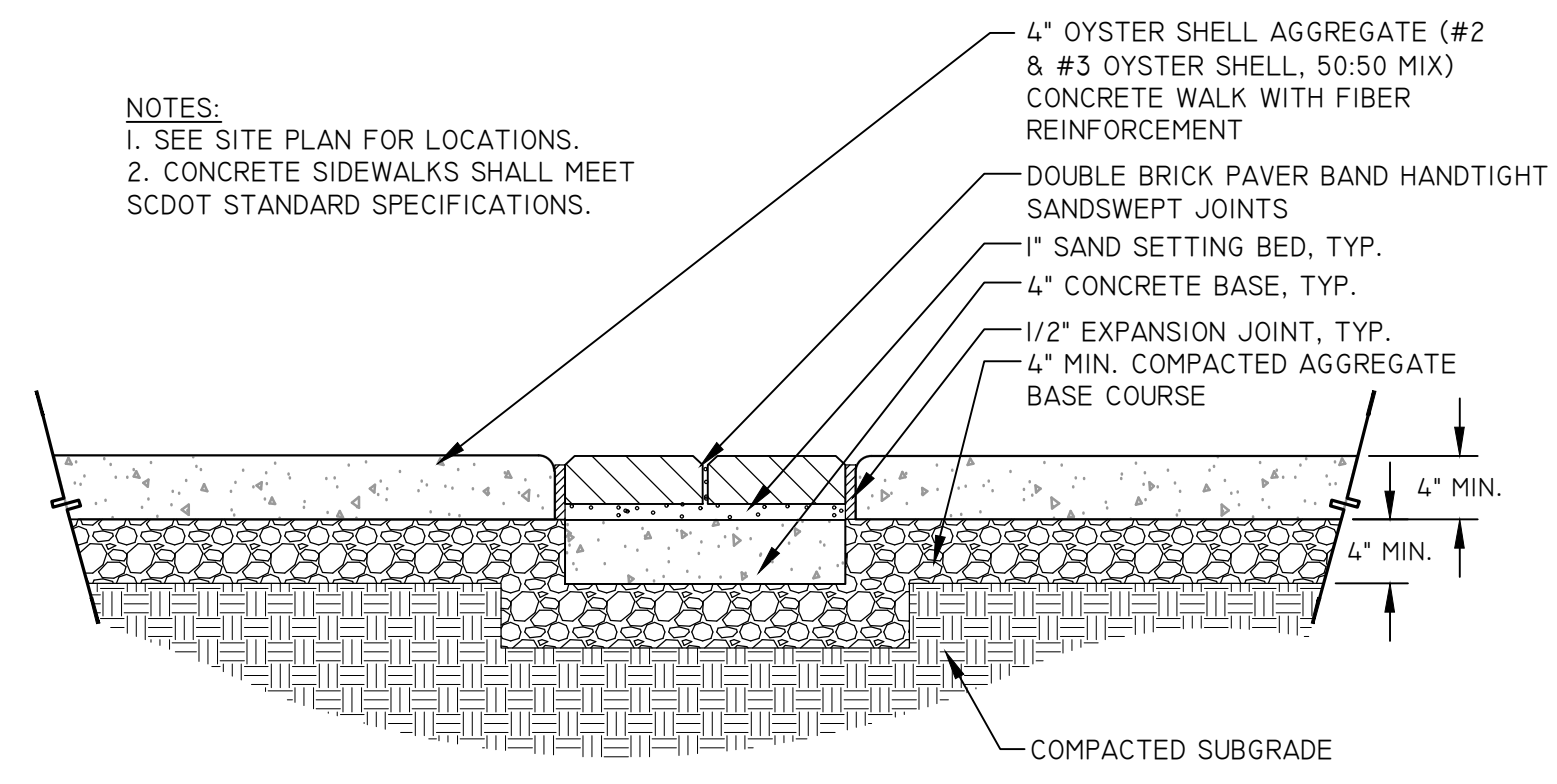
2
L5
CONCRETE PAVING AT TREE WELL
SCALE: 1/2" = 1'-0"



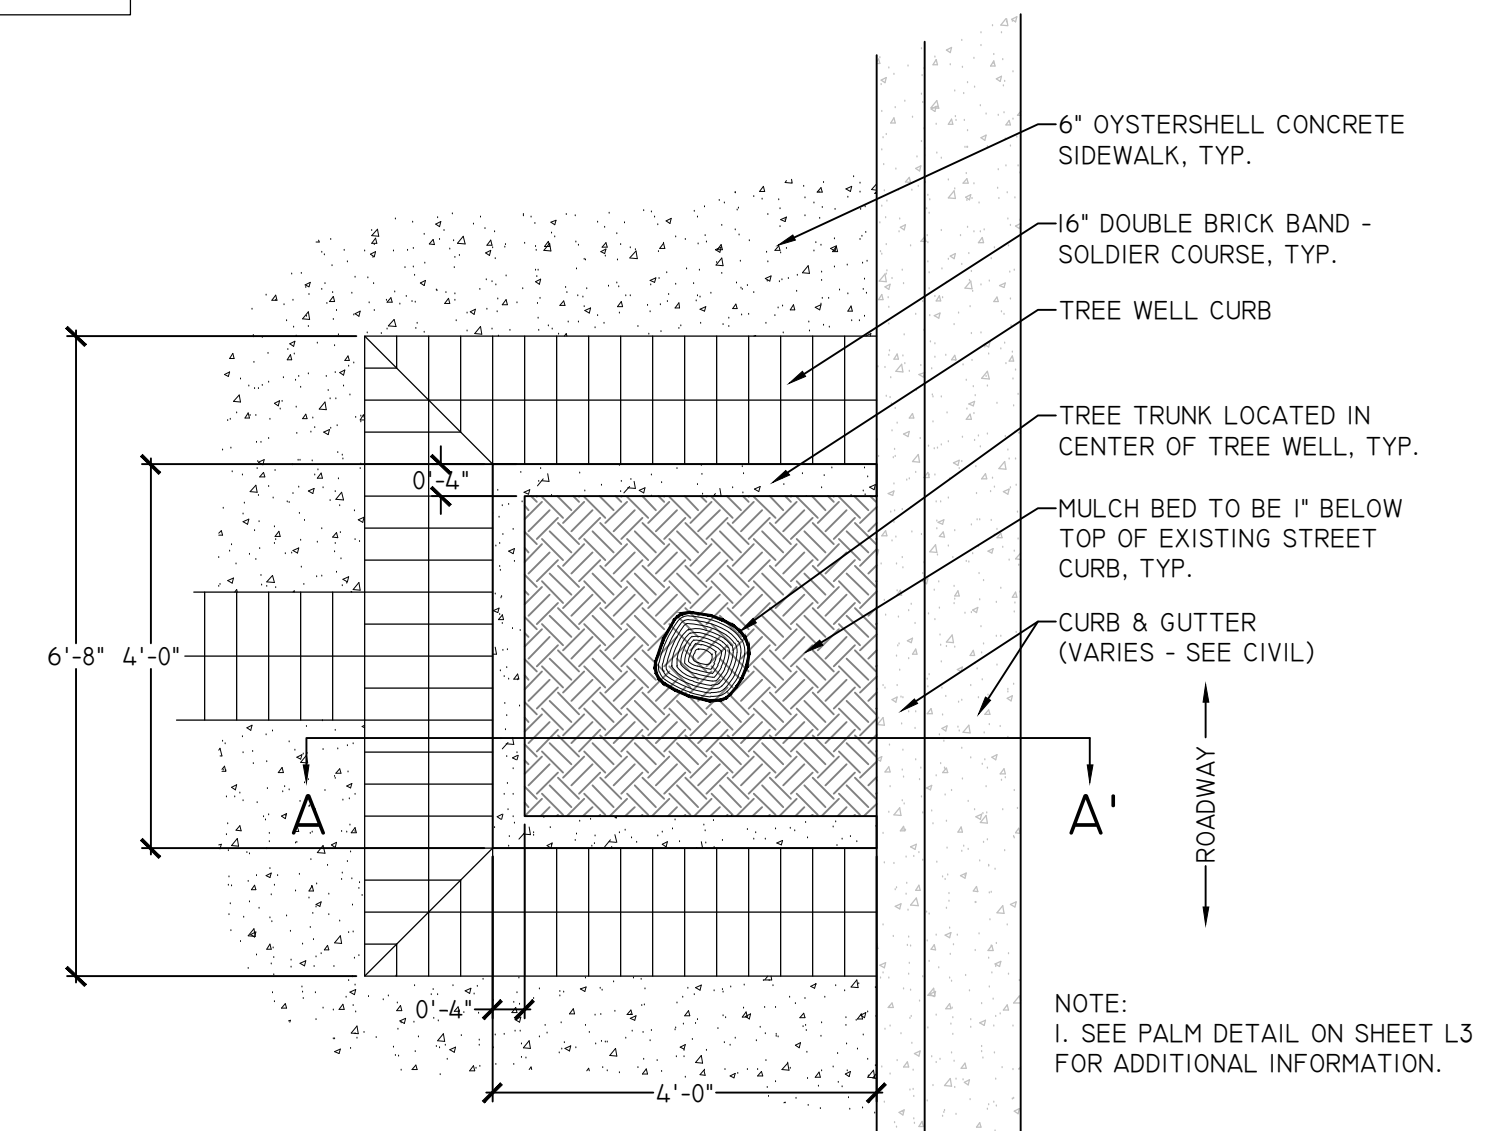A-A' - PAVEMENT BAND IN CONCRETE FIELD
SCALE: 1" = 1'-0"



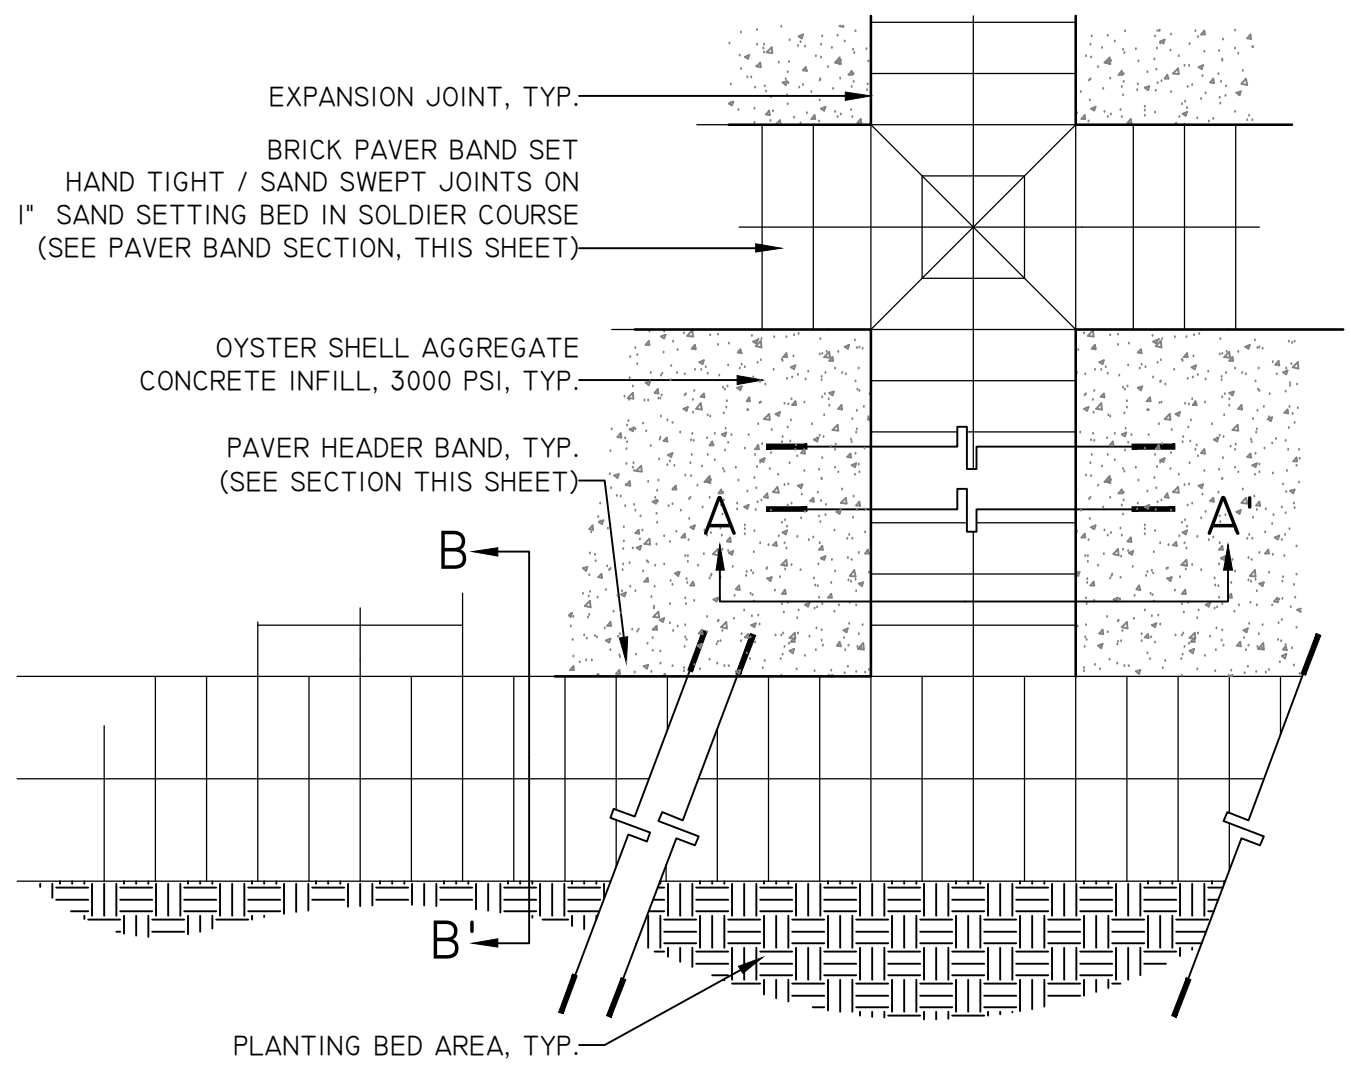1
L5
BRICK PAVING AT TREE WELL
SCALE: 1/2" = 1'-0"



PLAN - PAVEMENT BAND IN CONCRETE FIELD
SCALE: 1" = 1'-3"

5
L5
OYSTER SHELL CONCRETE AND BRICK PAVEMENT BAND DETAILS
SCALE: SEE ABOVE

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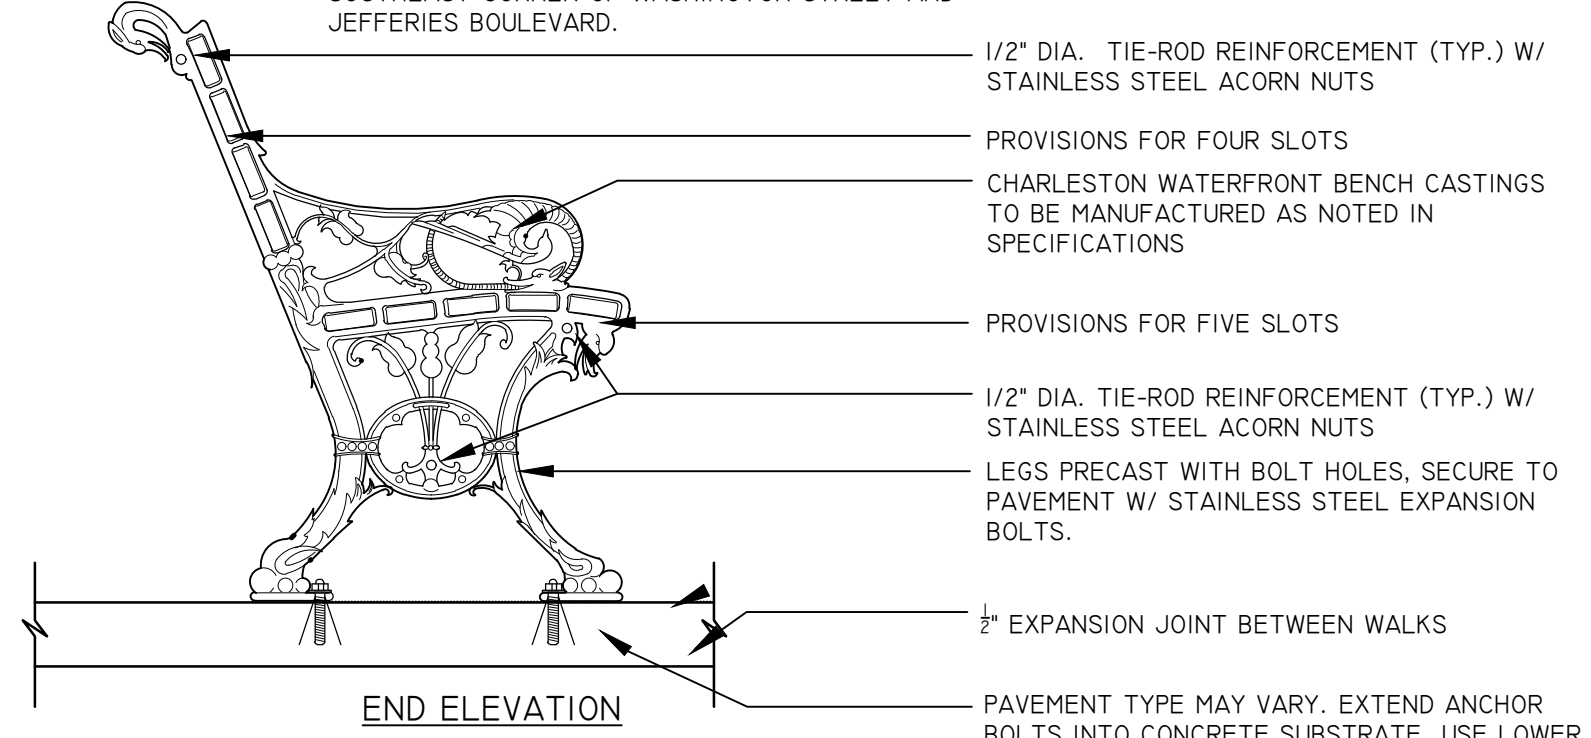
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FED. DIST. NO.	STATE	COUNTY	PROJECT ID	PROJECT NO.	ROUTE NO.	SHEET NO.	TOTAL SHEETS
3	S.C.	COLLETON	0041932	02-14011	SC 63		

BASIS OF DESIGN IS EXISTING BENCHES IN PLAZA AT SOUTHEAST CORNER OF WASHINGTON STREET AND JEFFERIES BOULEVARD.

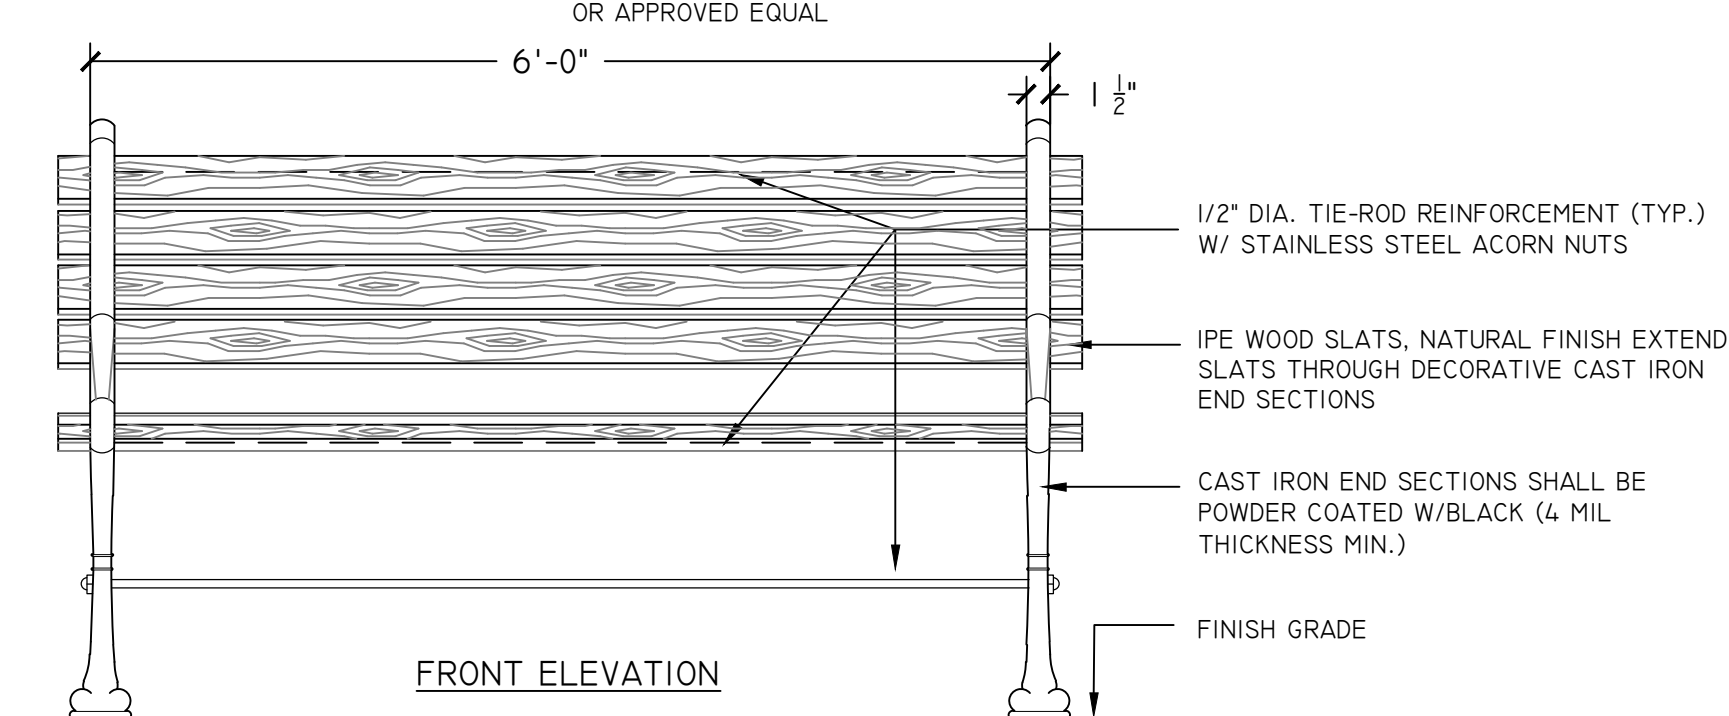


END ELEVATION

MANUFACTURER: J&M FOUNDRY, INC. OR APPROVED EQUAL
 MODEL: CHARLESTON WATERFRONT BENCH
 OR APPROVED EQUAL
 SEE SPECIFICATIONS


OR MANUFACTURER: VICTOR STANLEY
 MODEL MATCHING SHOWN
 DETAIL/SPECS

PAVEMENT TYPE MAY VARY. EXTEND ANCHOR BOLTS INTO CONCRETE SUBSTRATE. USE LOWER LEVELING NUTS ON BRICK PAVEMENT TO FLAT BEYOND ABOVE PAVEMENT SURFACE. ALL FASTENERS ARE TO BE STAINLESS STEEL.




FRONT ELEVATION

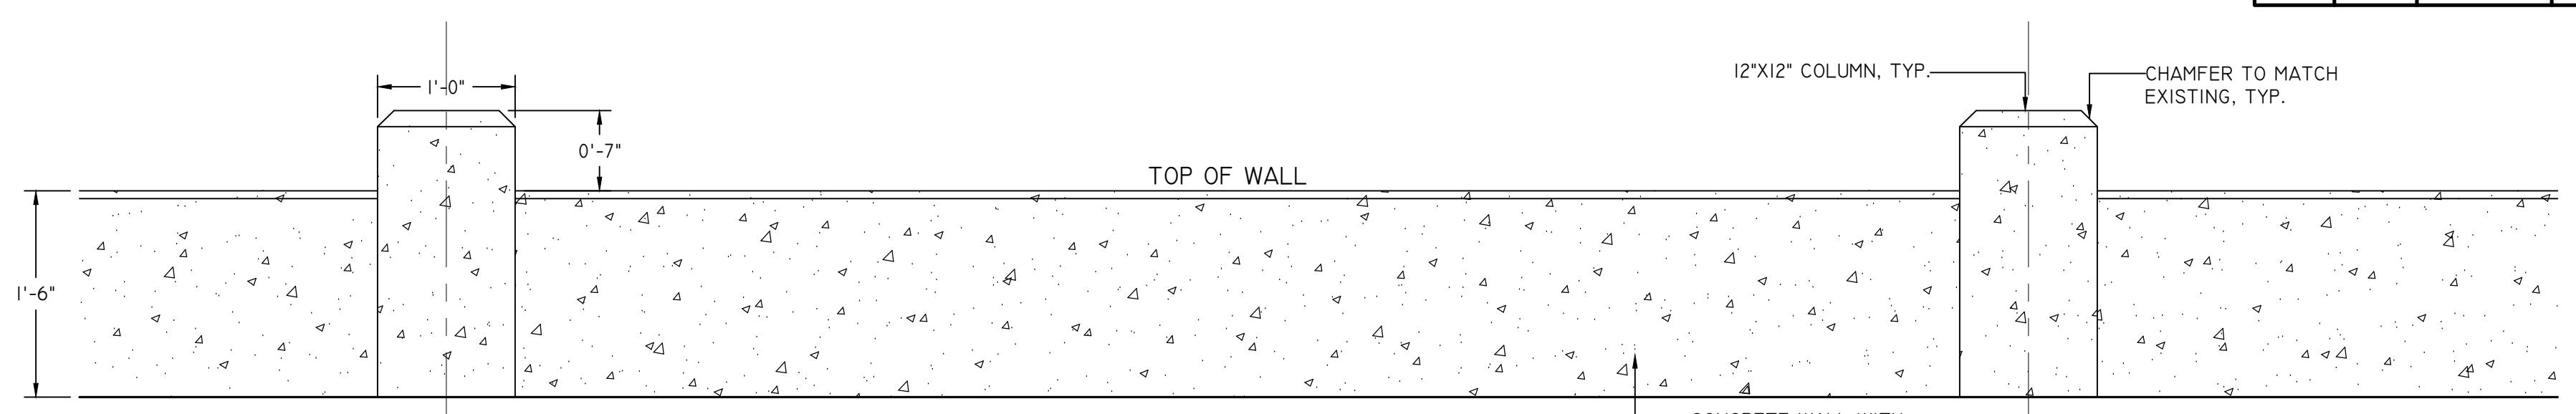1 BENCH DETAIL
 SCALE: 1" = 1'-0"




ELEVATION

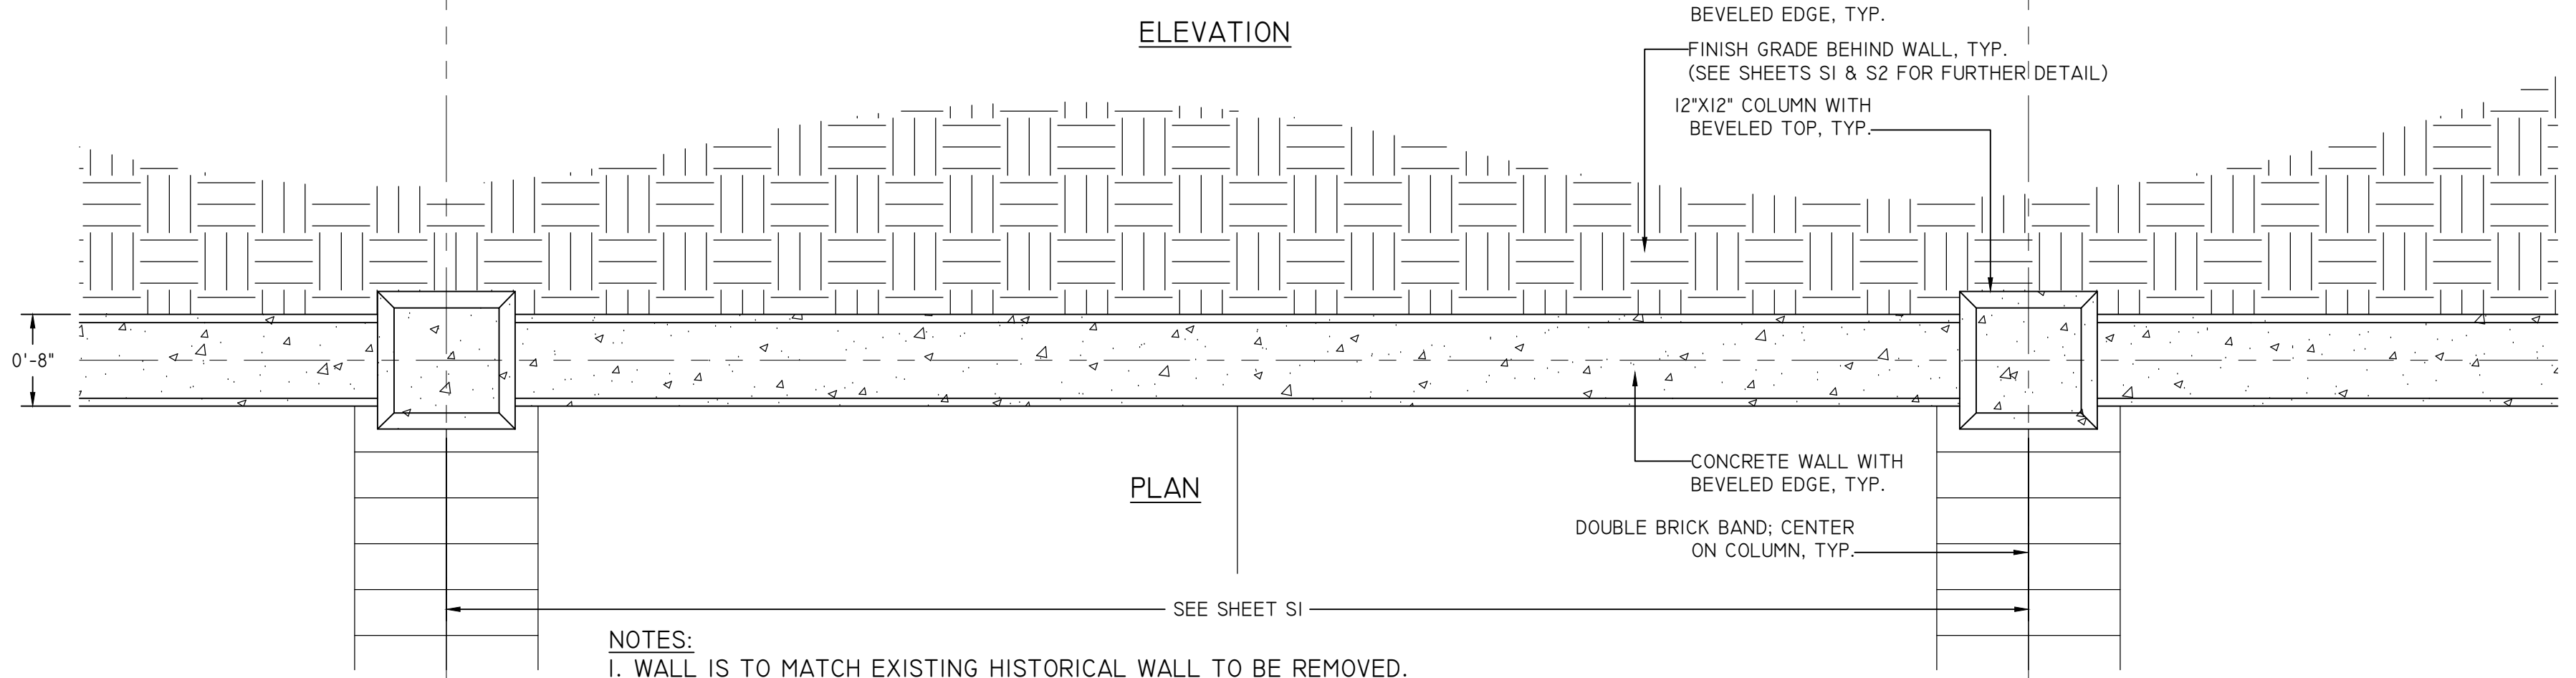

PLAN


NOTES:
 1. WALL IS TO MATCH EXISTING HISTORICAL WALL TO BE REMOVED.
 2. SEE SHEETS S1 & S2 FOR COLUMN LOCATIONS AND STRUCTURAL DETAILS. PRIOR TO CONSTRUCTION, CONTRACTOR SHALL PROVIDE SHOP DRAWINGS FOR OWNER APPROVAL.

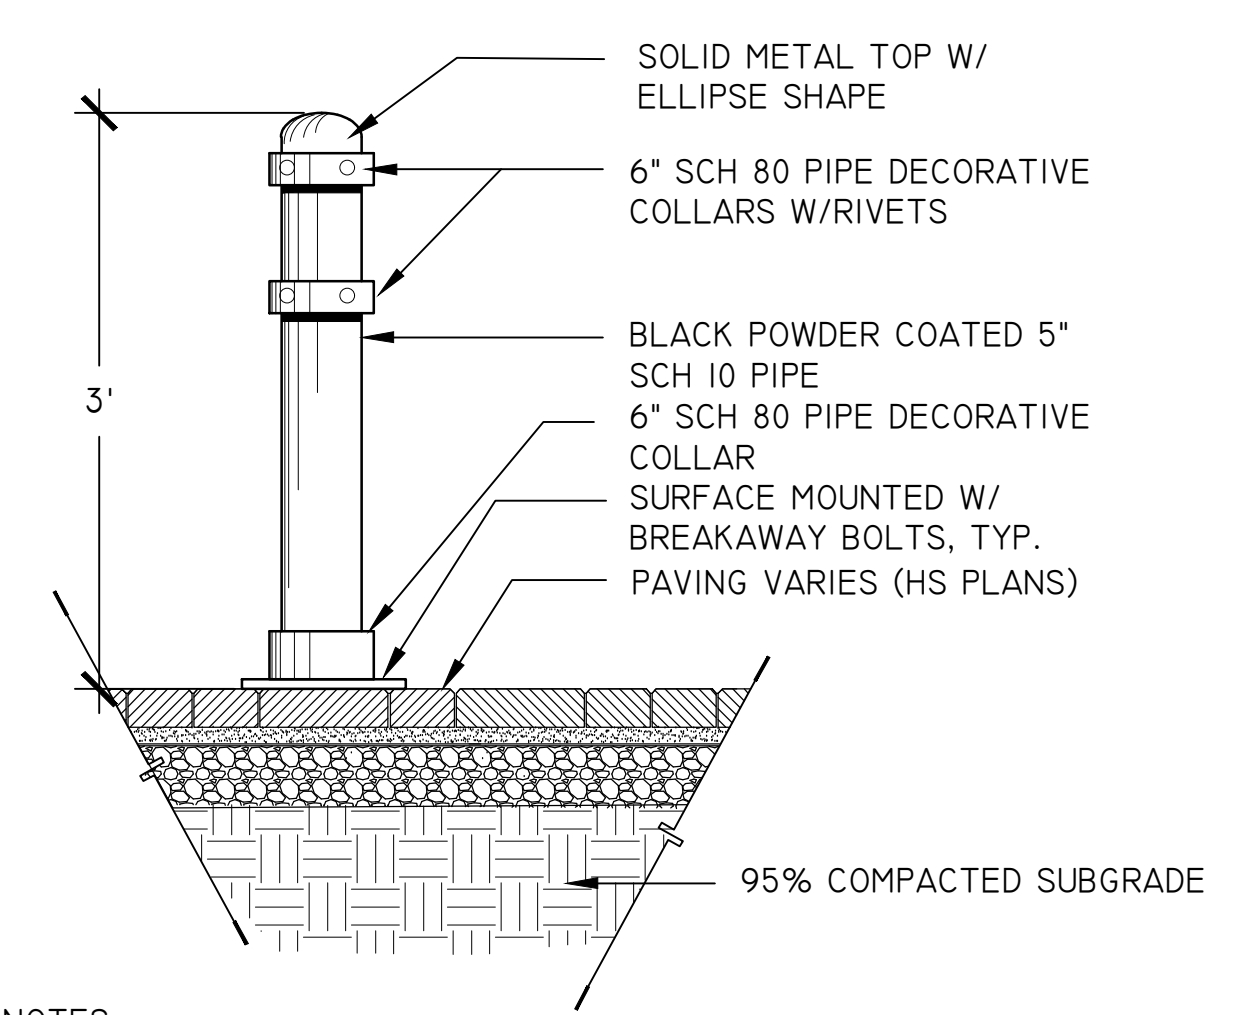2 HISTORIC CONCRETE WALL
 SCALE: 1" = 1'-0"




NOTES:
 1. BOLLARDS SHALL BE TYPE B-1, 6" BOLLARD W/COLLARS AS MANUFACTURED BY FAIRWEATHER (OR APPROVED EQUAL)
 2. ALL WELDS ARE TO BE CONTINUOUS AND GRINDED SMOOTH.
 3. ALL METAL SHALL BE FINISHED W/ A BLACK POWDER COAT FINISH (4 MIL MIN. THICKNESS)

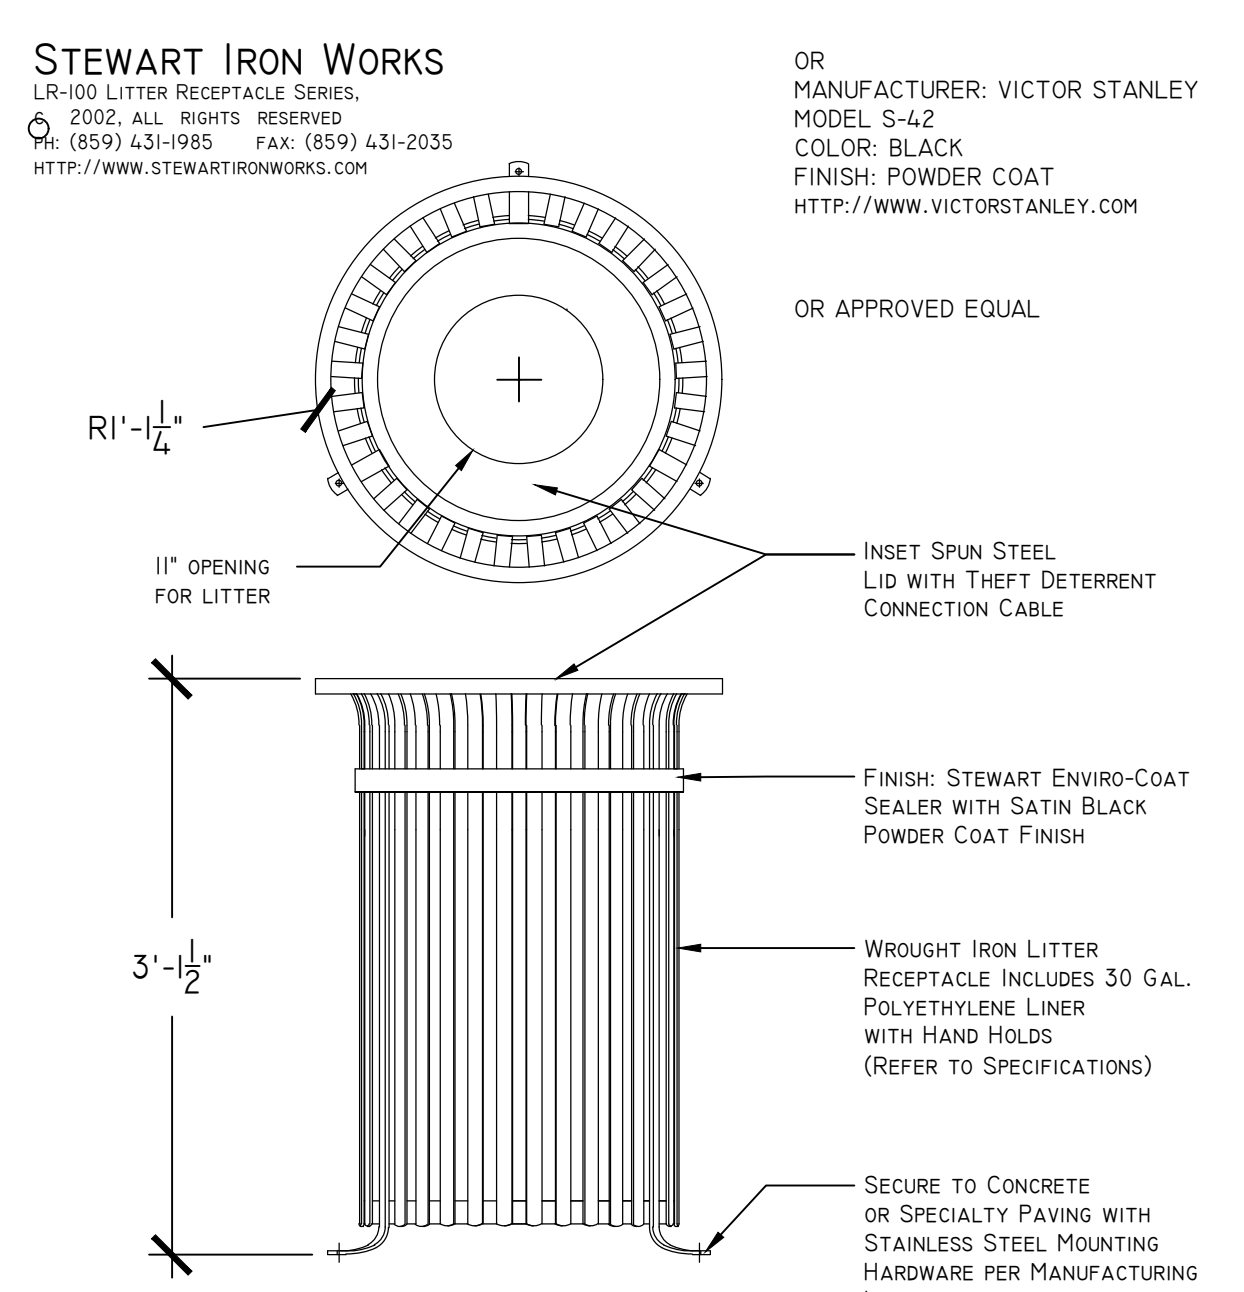
3 BOLLARD DETAIL
 SCALE: 1" = 1'-0"




4 TRASH RECEPTACLE
 SCALE: 1" = 1'-0"

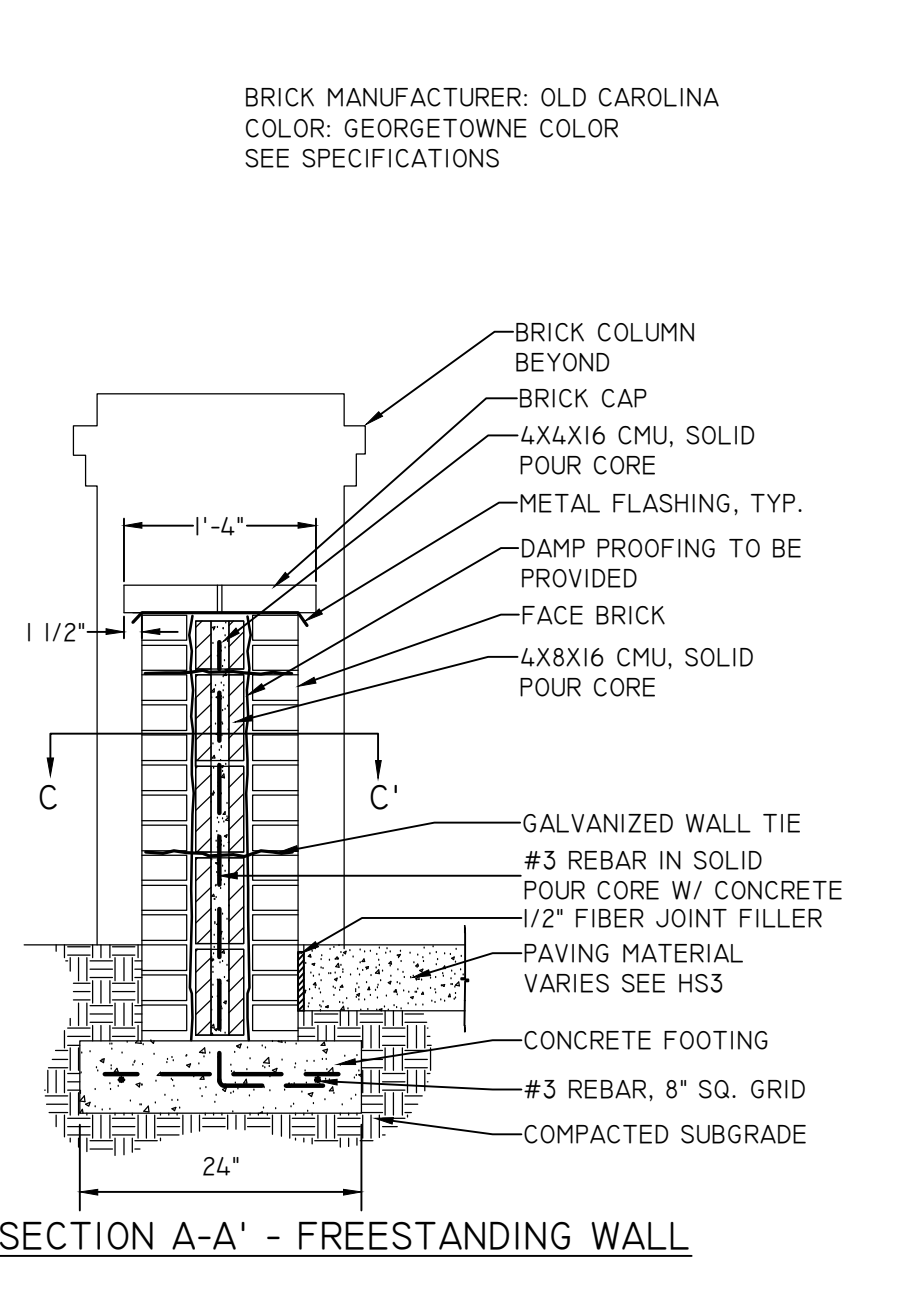


SECTION A-A' - FREESTANDING WALL

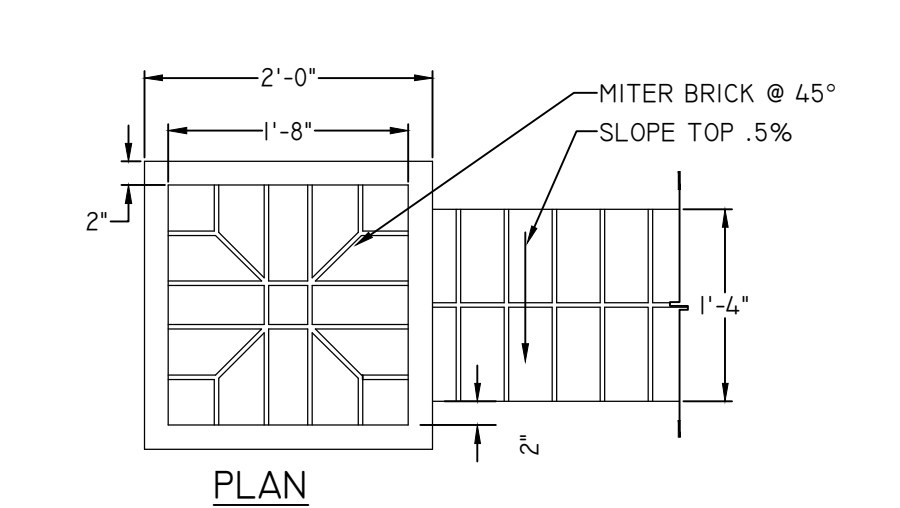


PLAN

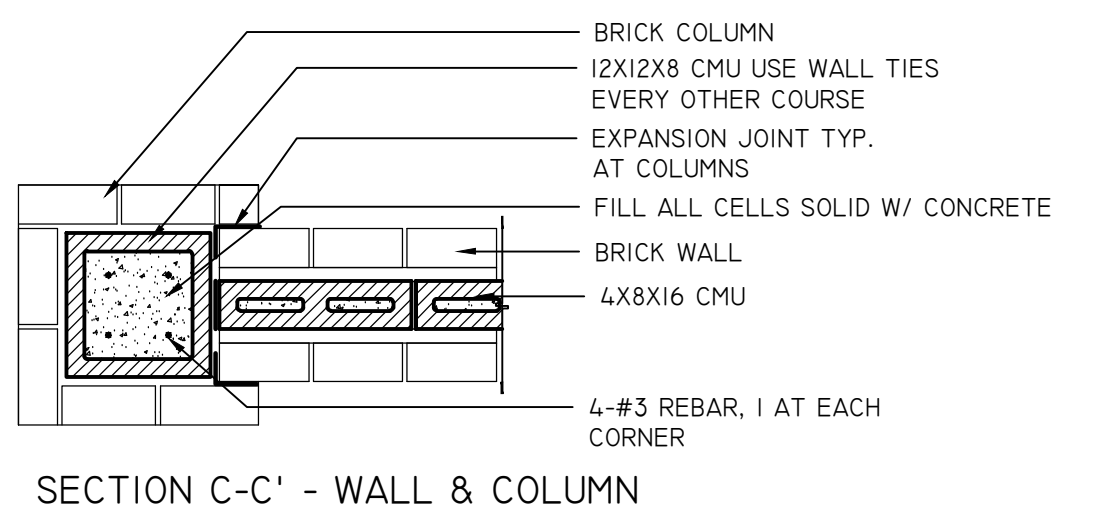

SECTION C-C' - WALL & COLUMN

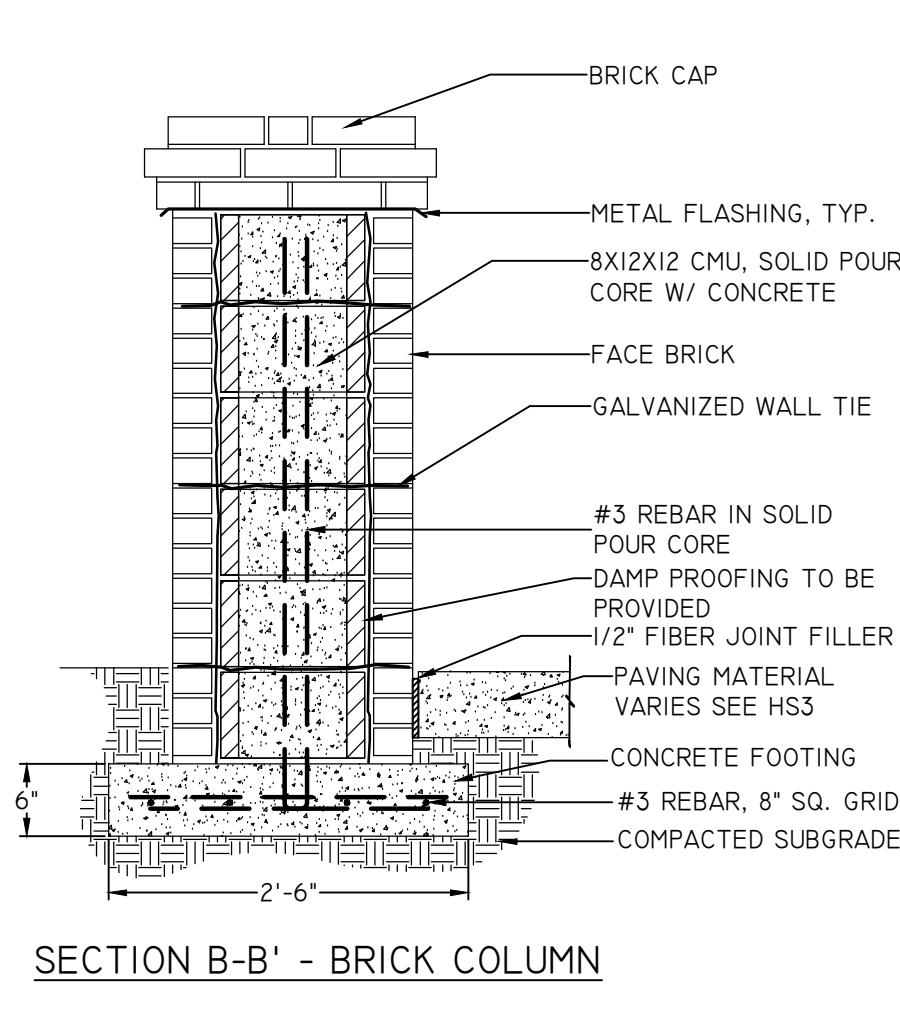

SECTION B-B' - BRICK COLUMN

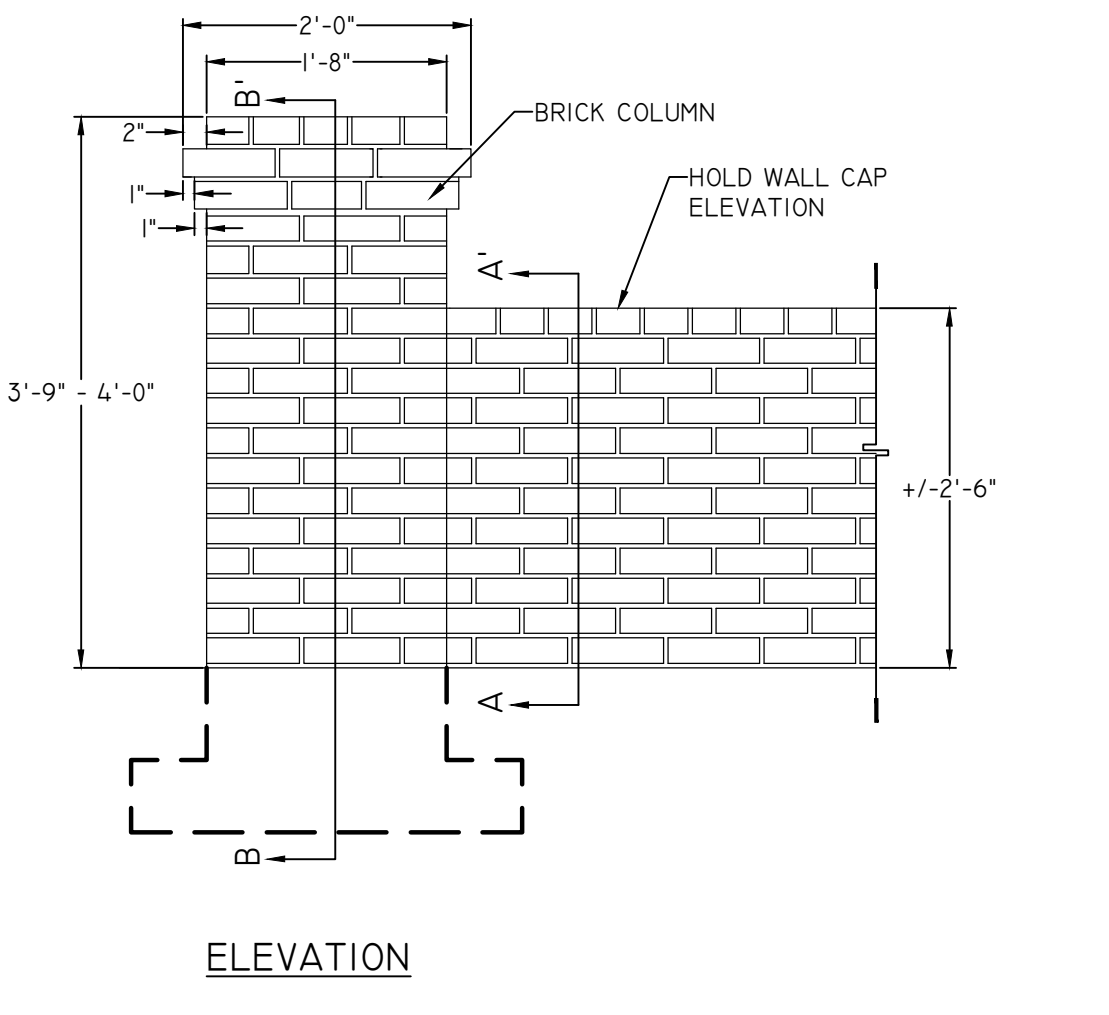

ELEVATION

5 BRICK COLUMN AND WALL
 SCALE: 3/4" = 1'-0"


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 Walterboro, South Carolina



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BY	DATE	REVISION

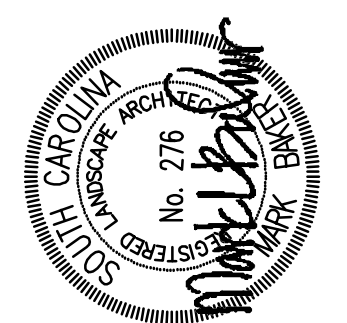SHEET NUMBER
L6

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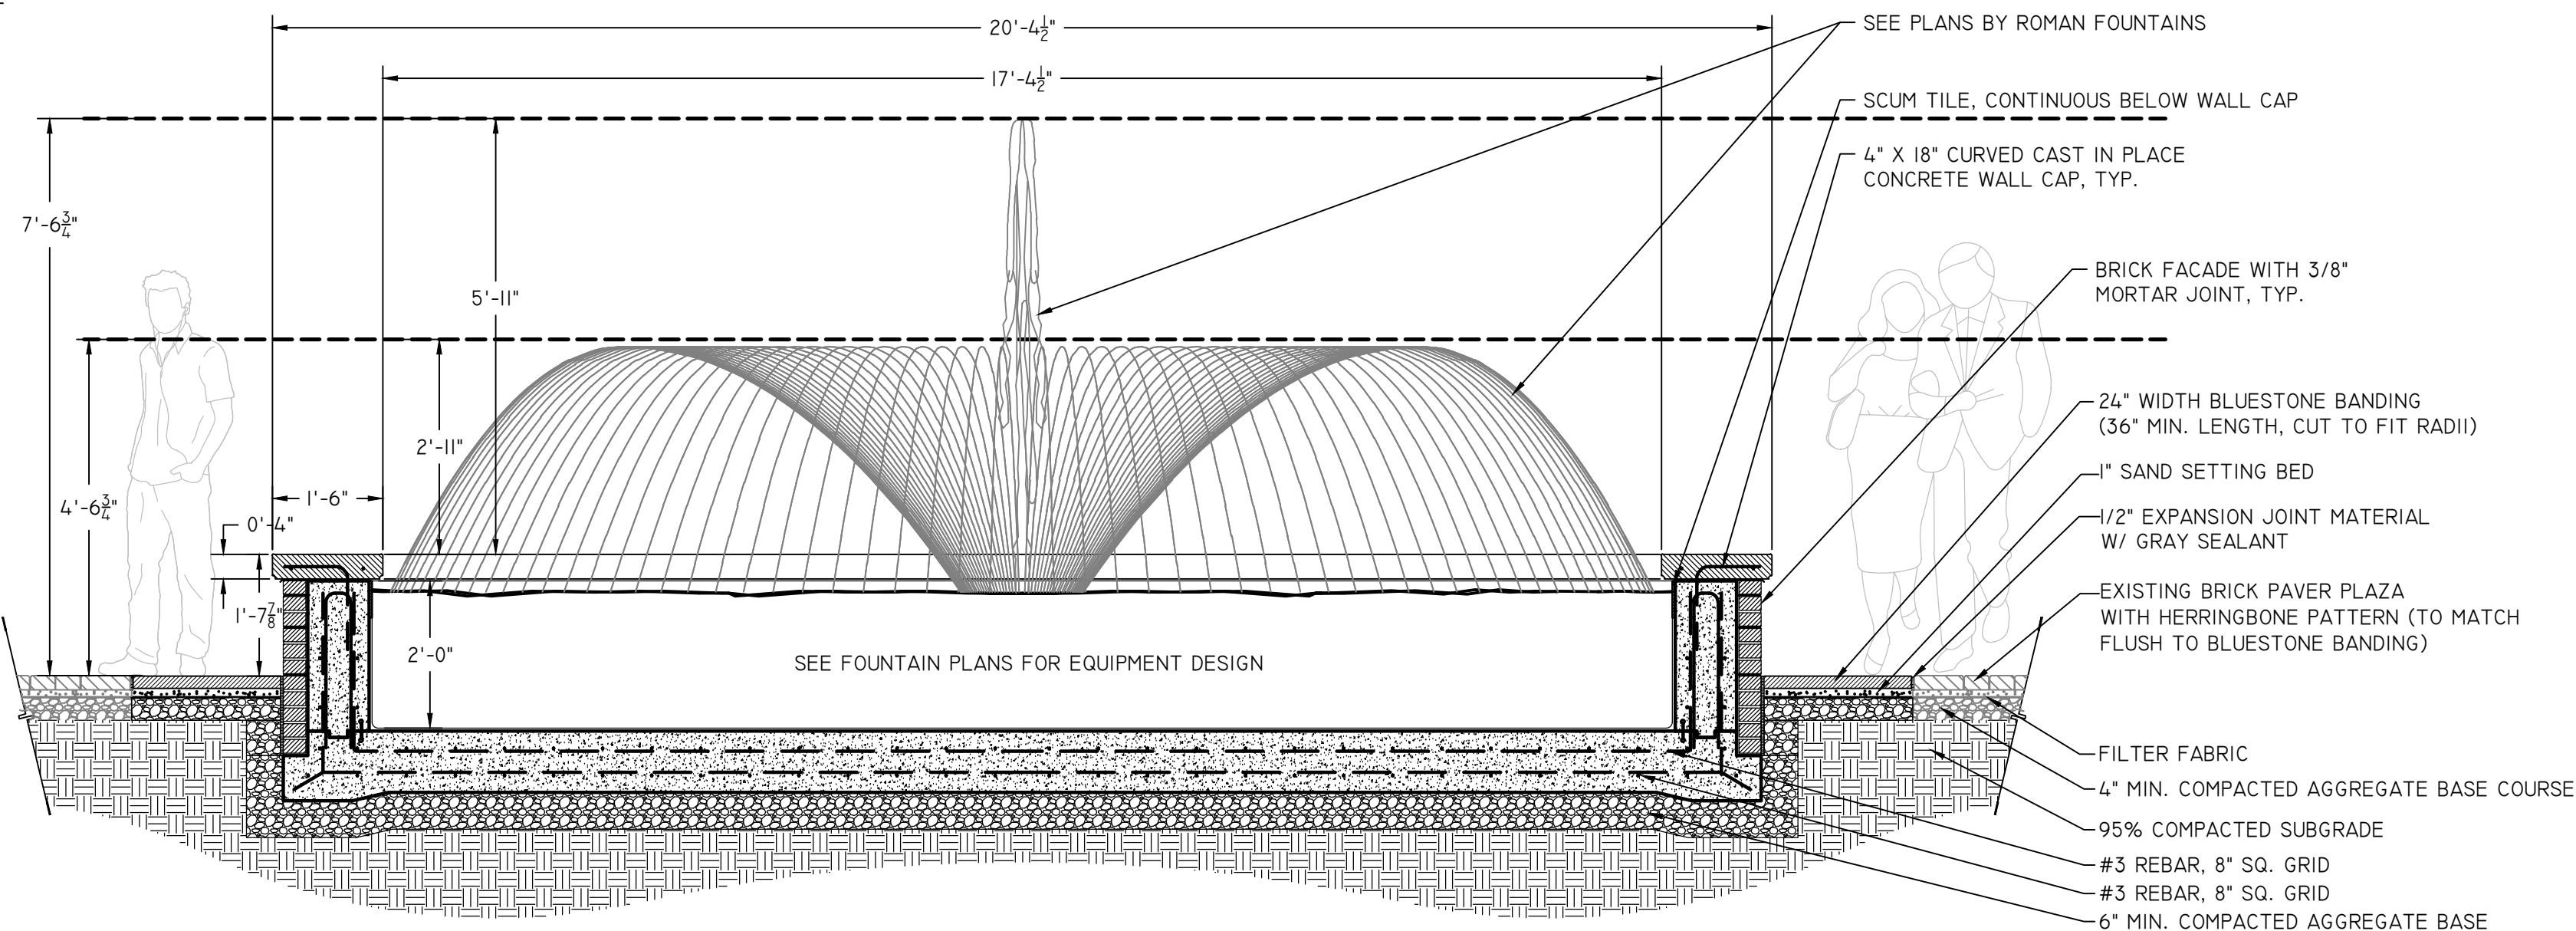
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FED. DIST. NO.	STATE	COUNTY	PROJECT ID	PROJECT NO.	ROUTE NO.	SHEET NO.	TOTAL SHEETS
3	S.C.	COLLETON	0041932	02-14011	SC 63		

GENERAL NOTES:

1. FOUNTAIN UTILITIES. SEE FOUNTAIN PLANS BY ROMAN FOUNTAINS FOR:
 - APPROXIMATE LOCATION OF FOUNTAIN EQUIPMENT
 - FINAL VAULT & CONTROL PANEL LOCATION AND SIZE
 - UTILITY CONNECTIONS.
 - ALL REQUIRED PUMPS, FILTERS, MECHANICAL AND ELECTRICAL FOR 100% COMPLETE SYSTEM.
 - LIGHTS, FLOOR DRAINS, RECIRCULATING RETURNS
2. THE CONTRACTOR SHALL EMPLOY A STRUCTURAL ENGINEER TO PERFORM THE STRUCTURAL DESIGN OF THE FOUNTAIN. STRUCTURAL DESIGN OF THE FOUNTAIN SHALL BE PROVIDED BY A PROFESSIONAL ENGINEER CURRENTLY LICENSED IN THE STATE OF SOUTH CAROLINA. SUBMIT STAMPED SHOP DRAWINGS OF FOUNTAIN REINFORCING STEEL FOR REVIEW.
3. HOLD TOP OF WALL CONSISTENT FOR THE ENTIRE LENGTH OF THE FOUNTAIN WALL.
4. VENEER ANCHOR (1/4 GAUGE GALVANIZED) SHALL BE REQUIRED AT MAXIMUMS OF 16" O.C. VERTICAL AND 12" O.C. HORIZONTAL IN A STAGGERED DIAMOND PATTERN FOR ALL CAST IN PLACE CONCRETE WALLS WITH BRICK VENEER.
5. PROVIDE MINIMUM 2% SLOPE OF FOUNTAIN FLOOR TO DRAIN.
6. REBAR SHALL NOT BE ANY LESS THAN 2" FROM FACE OF CONCRETE.
7. MOCK UPS AND SAMPLES OF PAVERS, TILES AND TOPCOATING SHALL BE PROVIDED TO OWNER BY CONTRACTOR. IN-PLACE MOCK UPS ARE ALLOWED.



SCHEDULE OF ITEMS

*PROVIDE BELOW REQUESTED PRODUCTS OR APPROVED EQUAL.

FOUNTAIN BRICK FACADE MANUFACTURER:
OLD CAROLINA
COLOR: GEORGETOWNE COLOR

MORTAR
COLOR: GRAY
JOINTS: TO BE GRAPEVINE

VENT WEEPS
WEEPVENT BY MORTAR NET SOLUTIONS
COLOR: GRAY

SCUM TILE:
SIMULATED POLISH TRAVERTINE, Noce SPT-NOCE BY NATIONAL POOL TILE GROUP

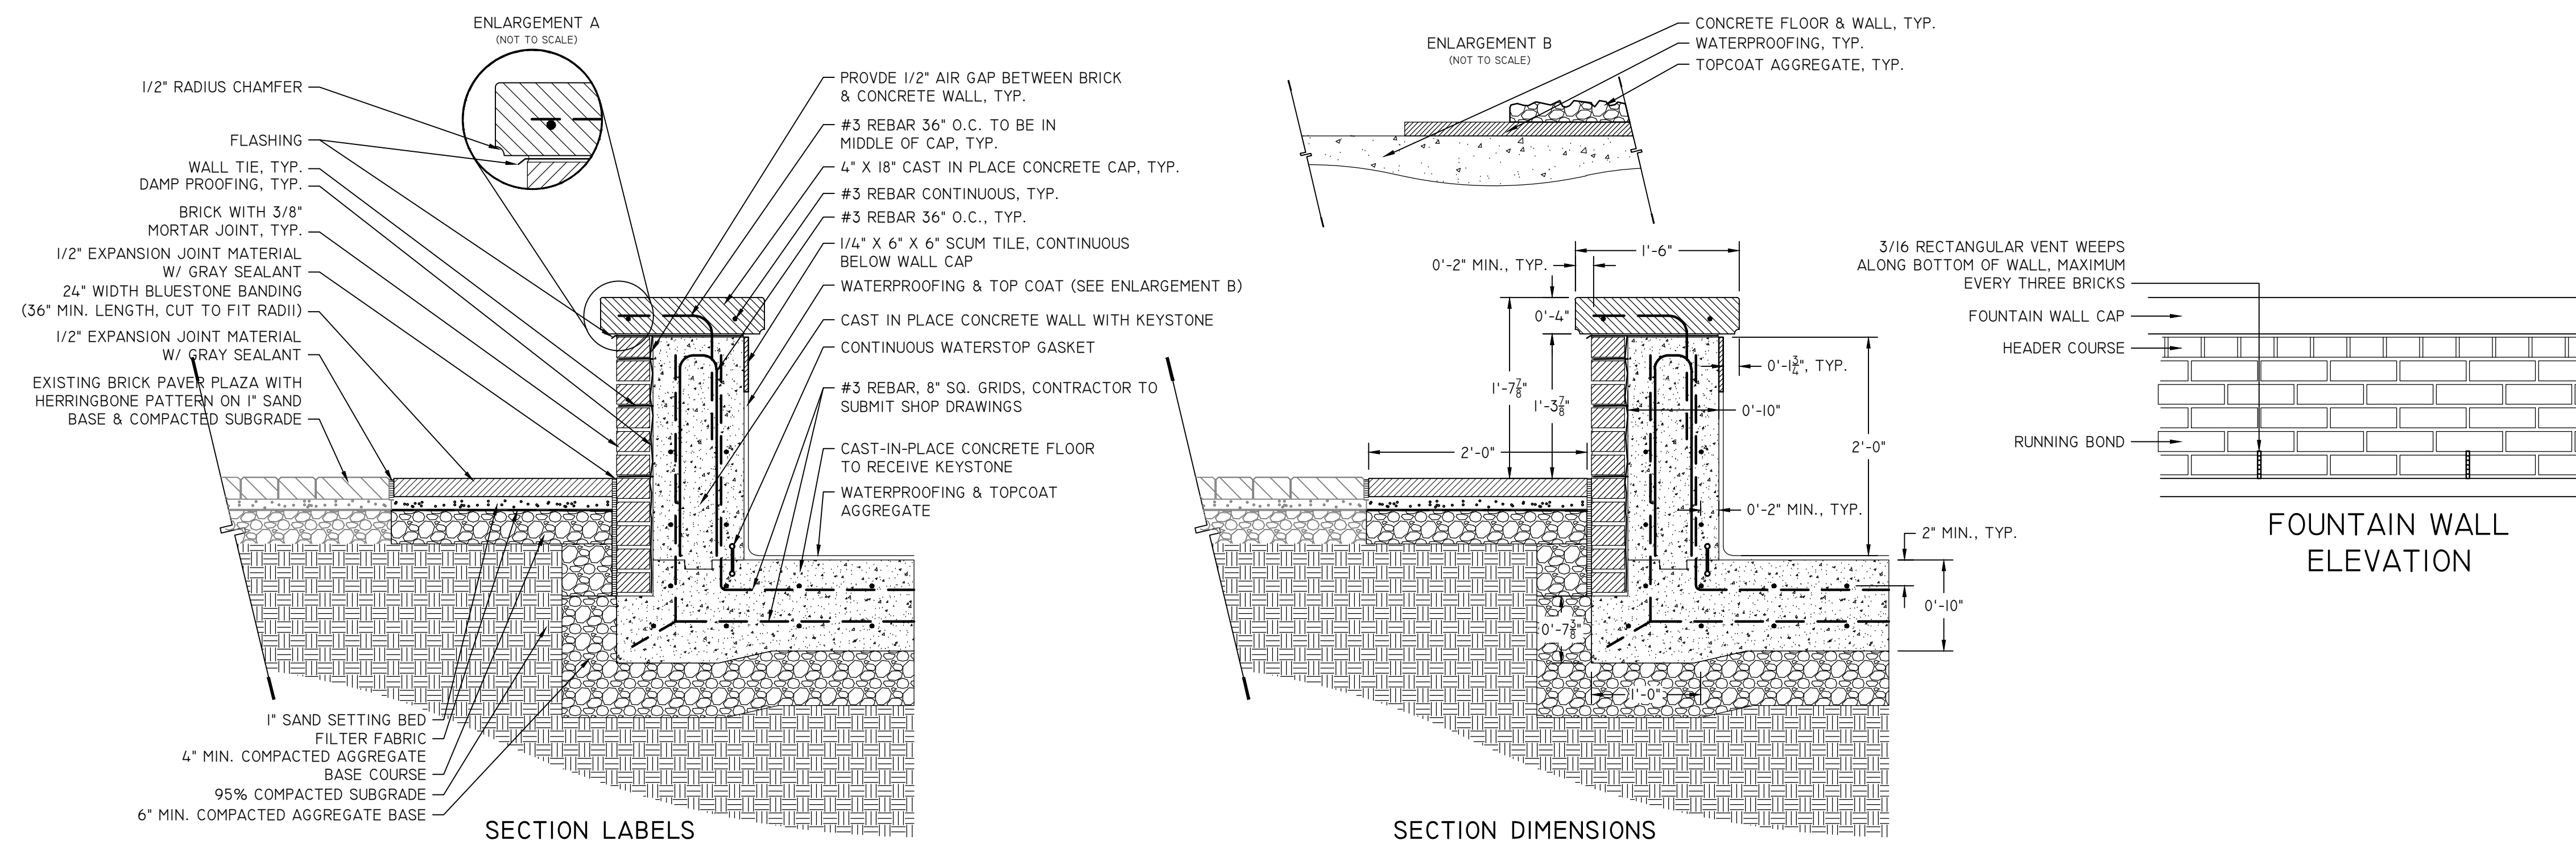
CAST IN PLACE CONCRETE CAP
COLOR: TO MATCH SW #7011 NATURAL CHOICE (SHERWIN WILLIAMS)

CAST IN PLACE CONCRETE CAP EXPANSION JOINTS
SHALL USE BACKER ROD AND CAULK SHALL MATCH CAP COLOR

WATERPROOFING
CIM 1000 BY CHASE INDUSTRIES
(APPLY PER MANUFACTURER RECOMMENDATIONS)

WATERPROOF TOPCOATING
PEBBLETEC MIDNIGHT BLUE BY PEBBLE TEC
(APPLY PER MANUFACTURER RECOMMENDATIONS)

1
L7 FOUNTAIN SECTION
SCALE: 1/2" = 1'-0"



2
L7 FOUNTAIN WALL ENLARGEMENT
SCALE: 1" = 1'-0"

DAVIS & FLOYD
SINCE 1954

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I-95 BUSINESS LOOP PHASES 1B
Walterboro, South Carolina



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RW: CJ
CHK: MB

REVISION	DATE	BY
#		

SHEET NUMBER
L7

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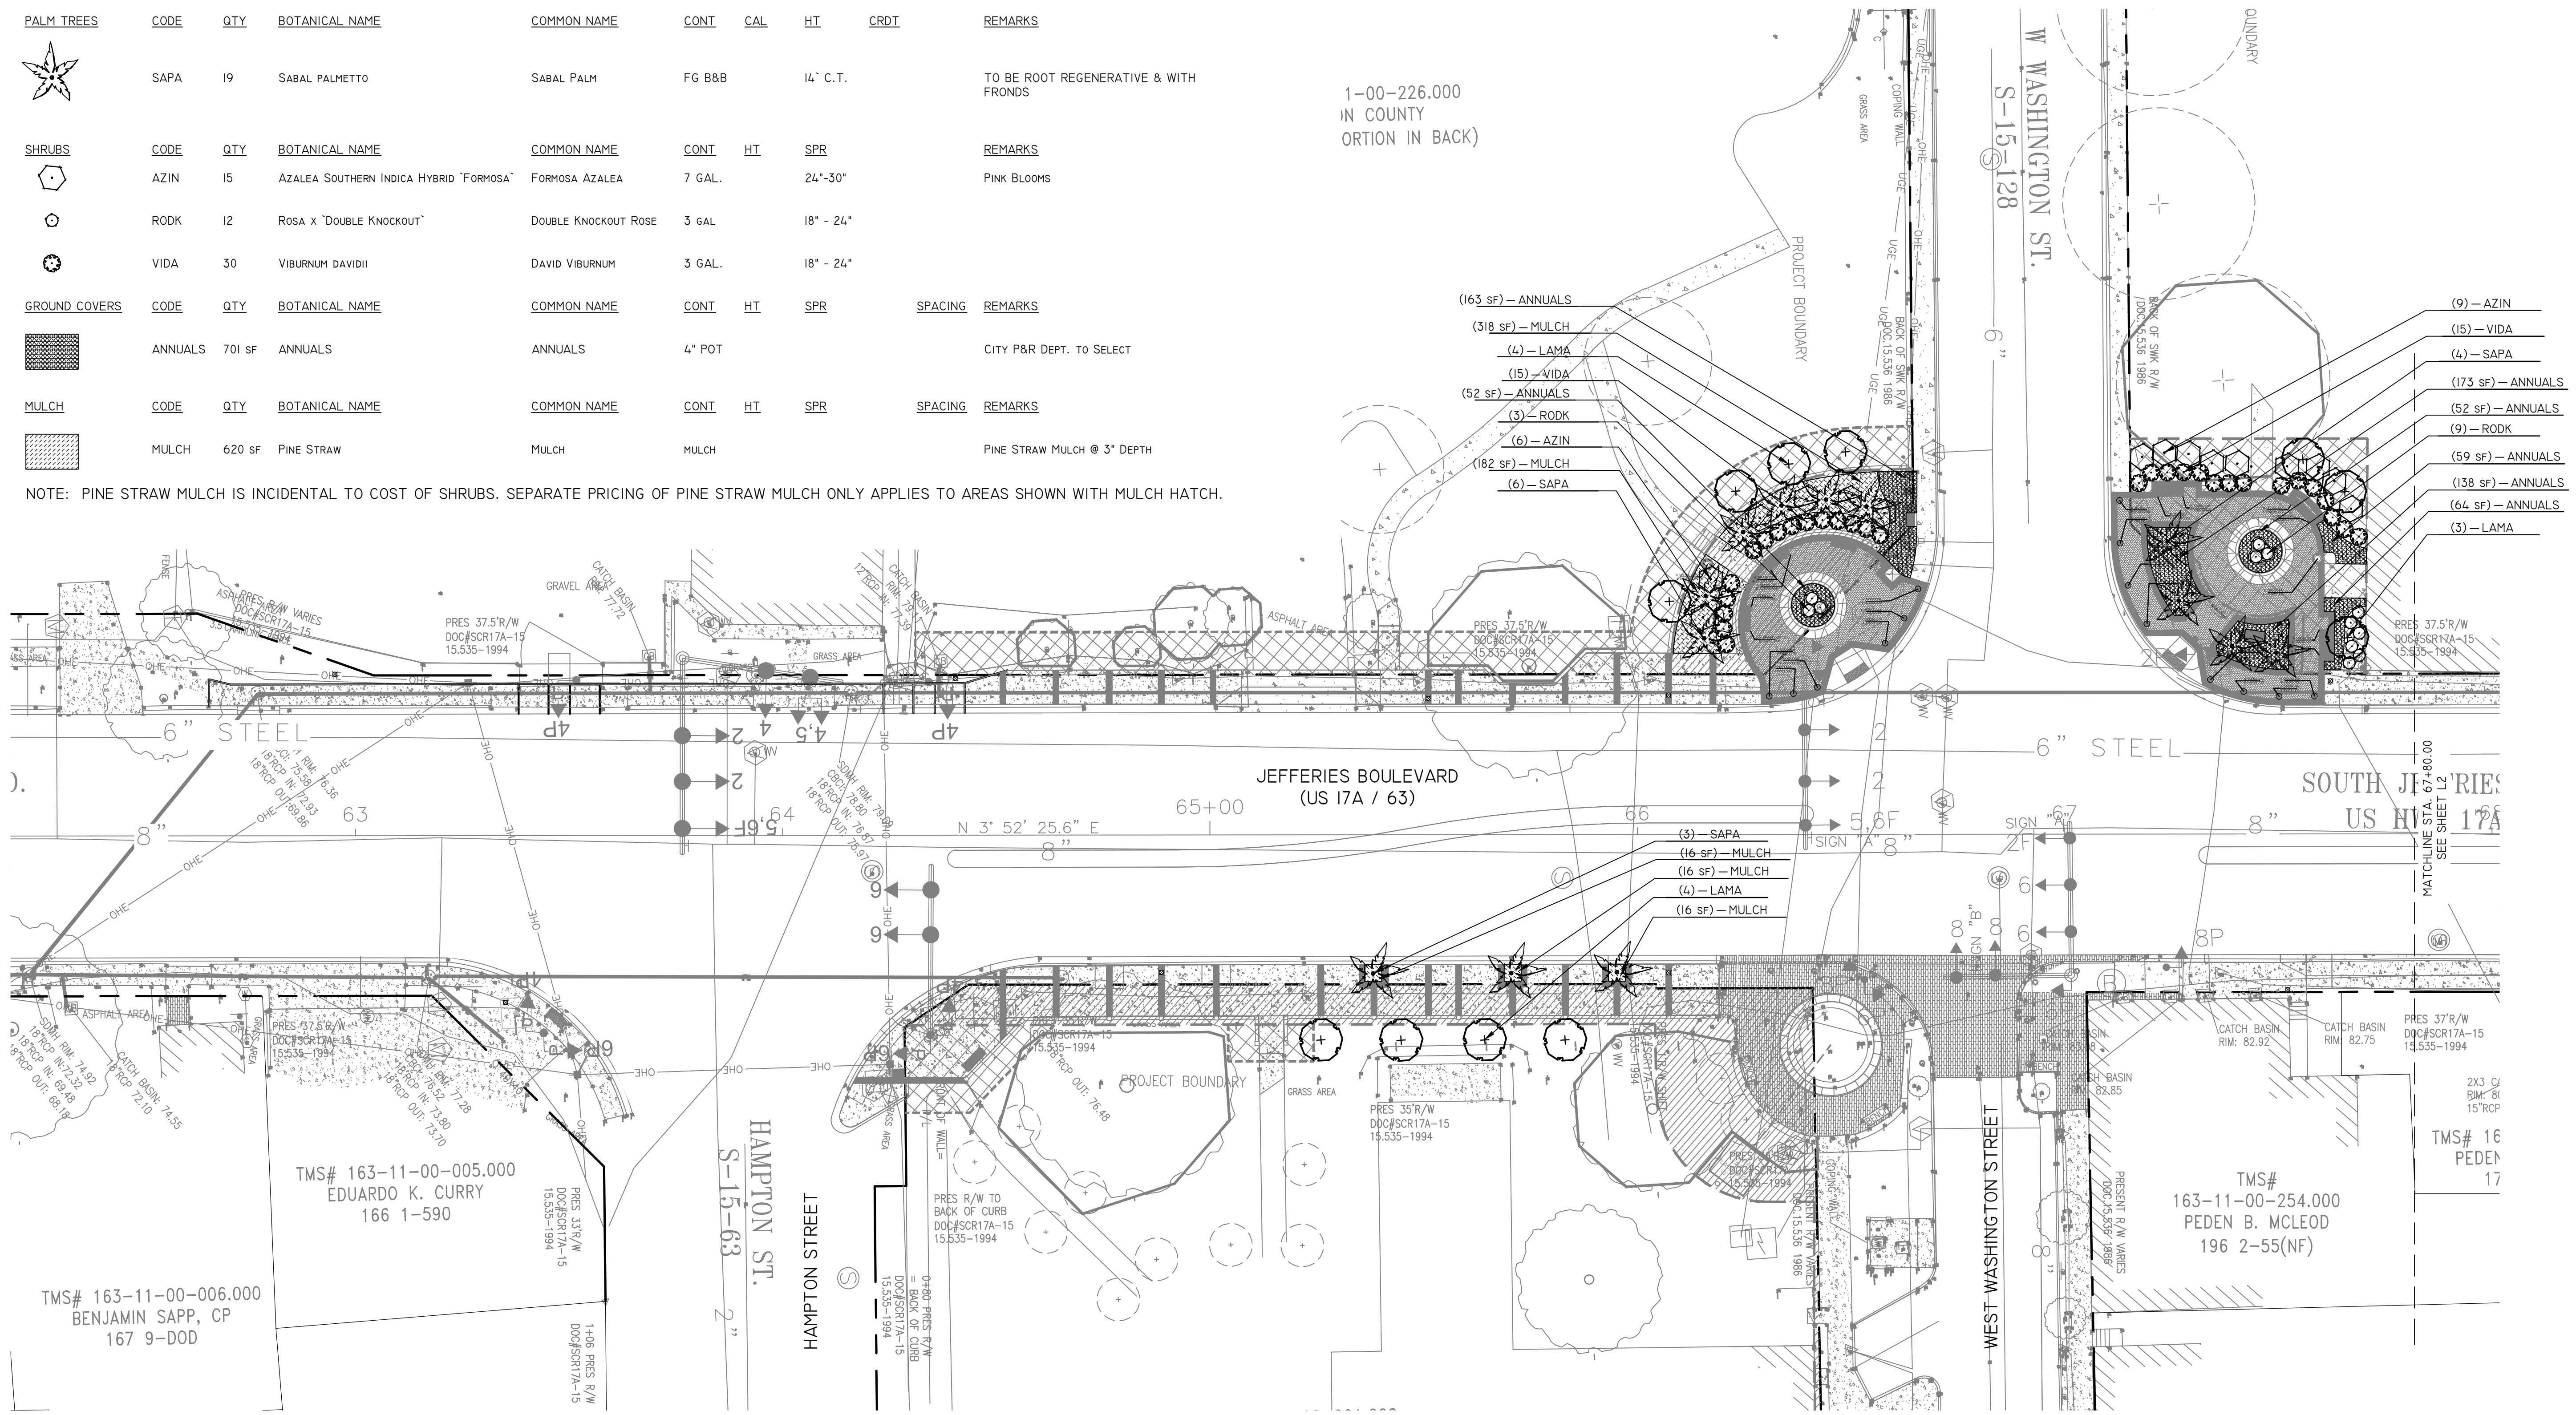
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FED. NO.	STATE	COUNTY	PROJECT ID	PROJECT NO.	ROUTE NO.	SHEET NO.	TOTAL SHEETS
3	S.C.	COLLETON	0041932	02-14011	SC 63		


PHASE IB PLANT SCHEDULE

FLOWERING TREES	CODE	QTY	BOTANICAL NAME	COMMON NAME	CONT	CAL	HT	CRDT	REMARKS
	LAMA	11	LAGERSTROEMIA X FAURIEI 'MUSKOGEE'	MUSKOGEE CRAPE MYRTLE	FG B&B	2" CAL.	12'-16"	I	SINGLE LEADER
PALM TREES	CODE	QTY	BOTANICAL NAME	COMMON NAME	CONT	CAL	HT	CRDT	REMARKS
	SAPA	19	SABAL PALMETTO	SABAL PALM	FG B&B		14' C.T.		TO BE ROOT REGENERATIVE & WITH FRONDS
SHRUBS	CODE	QTY	BOTANICAL NAME	COMMON NAME	CONT	HT	SPR	REMARKS	
	AZIN	15	AZALEA SOUTHERN INDICA HYBRID 'FORMOSA'	FORMOSA AZALEA	7 GAL.		24"-30"		PINK BLOOMS
	RODK	12	ROSA X 'DOUBLE KNOCKOUT'	DOUBLE KNOCKOUT ROSE	3 GAL.		18" - 24"		
	VIDA	30	VIBURNUM DAVIDII	DAVID VIBURNUM	3 GAL.		18" - 24"		
GROUND COVERS	CODE	QTY	BOTANICAL NAME	COMMON NAME	CONT	HT	SPR	REMARKS	
	ANNUALS	701 SF	ANNUALS	ANNUALS	4" POT				CITY P&R DEPT. TO SELECT
MULCH	CODE	QTY	BOTANICAL NAME	COMMON NAME	CONT	HT	SPR	REMARKS	
	MULCH	620 SF	PINE STRAW	MULCH	MULCH				PINE STRAW MULCH @ 3" DEPTH

NOTE: PINE STRAW MULCH IS INCIDENTAL TO COST OF SHRUBS. SEPARATE PRICING OF PINE STRAW MULCH ONLY APPLIES TO AREAS SHOWN WITH MULCH HATCH.



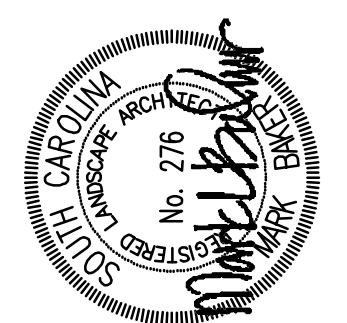I-95 BUSINESS LOOP PHASES IB
Walterboro, South Carolina

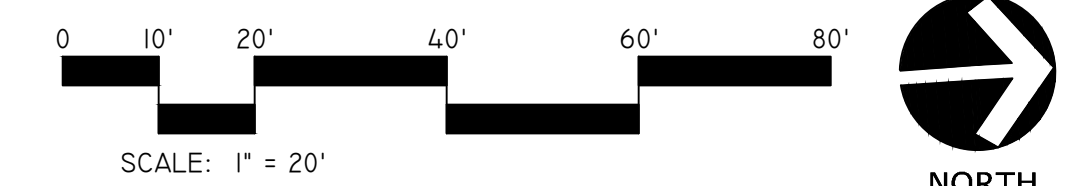


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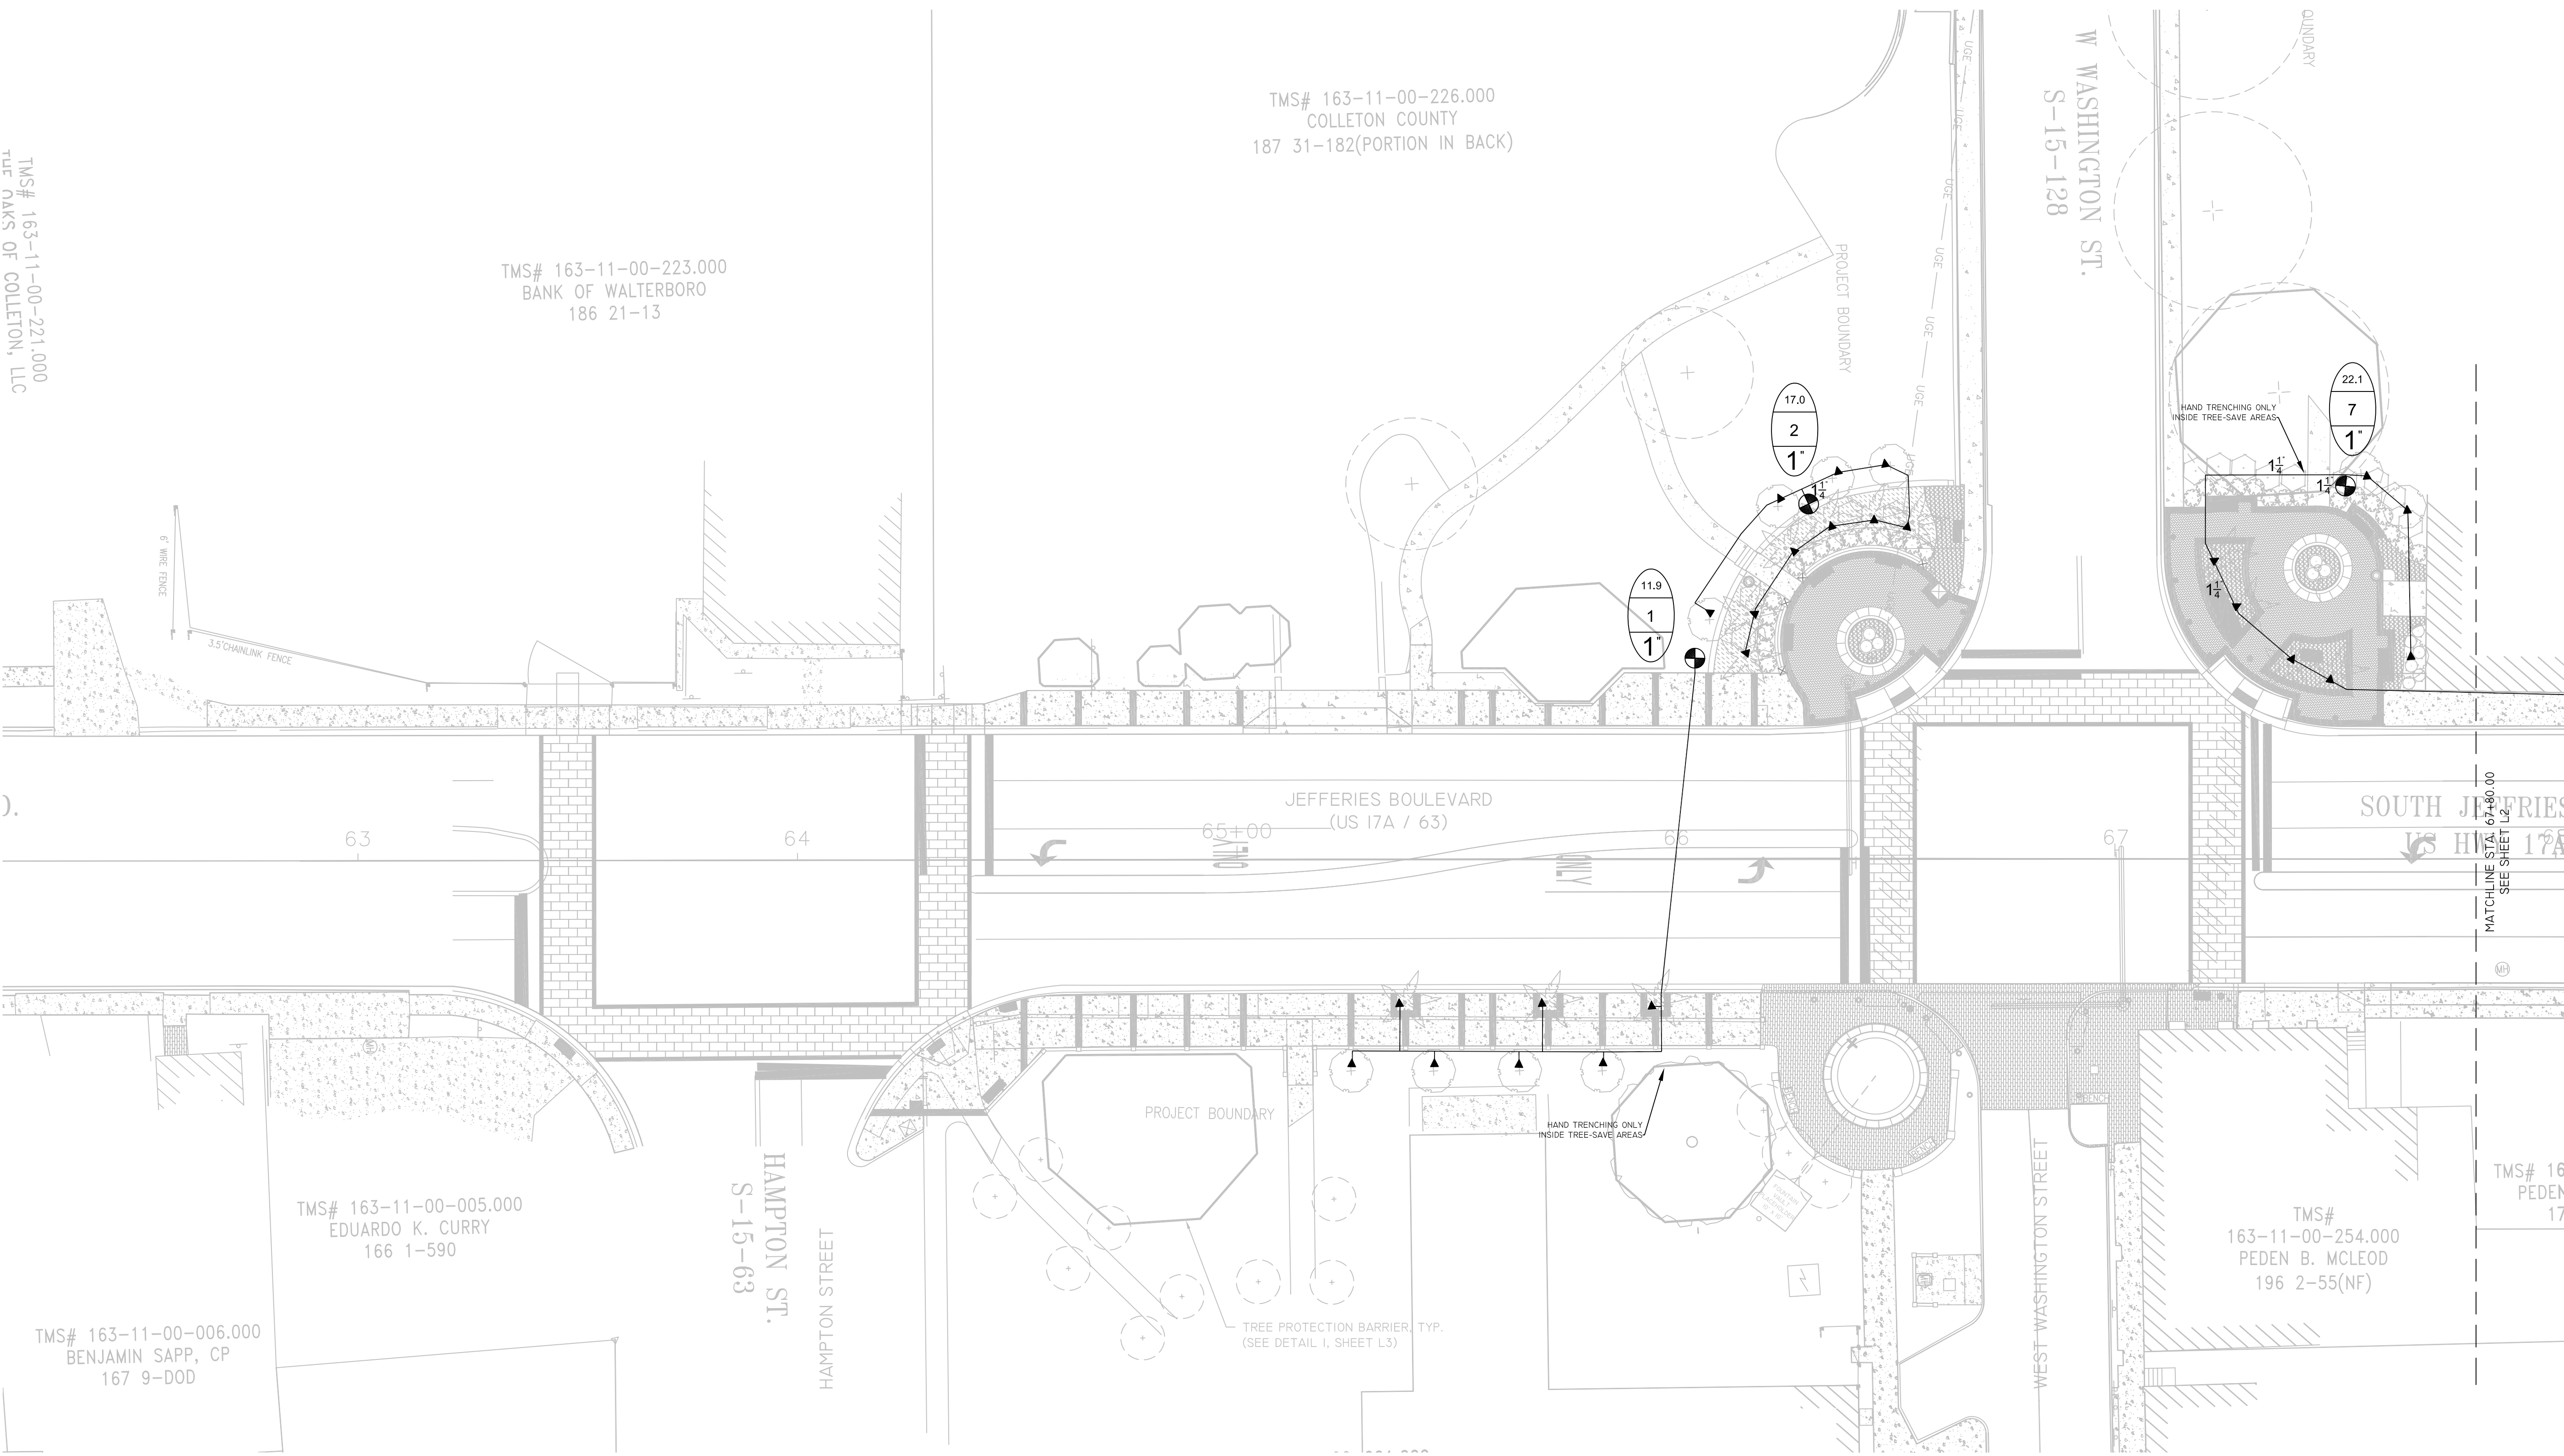
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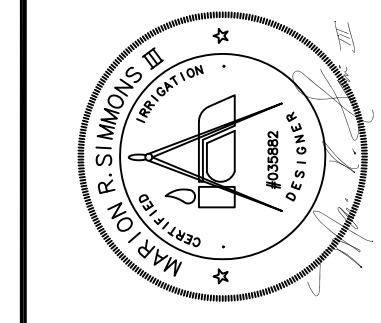
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95% PLANS
I-95 BUSINESS LOOP PHASES 1B
 Walterboro, South Carolina



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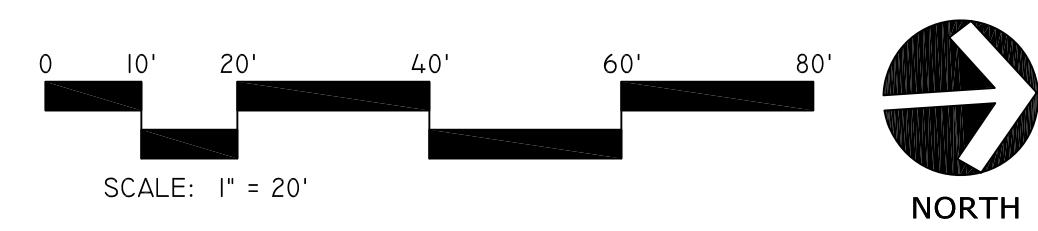
Simmons Irrigation Supply
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 526 SIDNEYS ROAD
 WALTERBORO, SC 29488
 PH: (843)538-5566
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FED. RD. DIV. NO.	STATE	COUNTY	PROJECT ID	PROJECT NO.	ROUTE NO.	SHEET NO.	TOTAL SHEETS
3	S.C.	COLLETON	0041932	02-14011	SC 63		

PRODUCTS

RAIN BIRD ESP-LXME SERIES CONTROLLER (OR APPROVED EQUAL)

- FLEXIBLE FEATURES AND MODULAR OPTIONS MAKING CONTROLLER IDEAL FOR A WIDE VARIETY OF APPLICATIONS INCLUDING LIGHT COMMERCIAL, COMMERCIAL, AND INDUSTRIAL IRRIGATION SYSTEMS.
- MODULAR OPTIONS INCLUDE: MODULAR STATION CAPACITY, FLOW SENSING, METAL CASE AND PREDESTAL, ETC. MANAGER SMART CARTRIDGES AND 10 CENTRAL COMMUNICATION CARTRIDGES.
- THESE OPTIONS FIELD INSTALLED AND CAN UPGRADE AND ENHANCE ESP-LXME AT ANY FUTURE TIME.
- CONTROLLER UTILIZES RAIN BIRD ESP EXTRA-SIMPLE PROGRAMMING USER INTERFACE.
- DIAL SWITCHES AND BUTTONS INTERFACE WITH RAIN BIRD STANDARD CONTROLLER INTERFACE FOR THE IRRIGATION INDUSTRY.
- LARGE LCD DISPLAY INCORPORATES SOFTKEY TEXT LABELS FOR BUTTON FUNCTIONS RATHER THAN DEDICATED BUTTONS.
- THE ESP-LXME CONTROLLER IS EASY TO INSTALL WITH SPACIOUS CASE AND QUICK-CONNECT TERMINALS MAKING INSTALLATION FAST AND EASY.
- MULTIPLE SIZE WIRING INDOORS ARE PROVIDED ON BOTTOM AND BACK SIDE OF CASE TO ADAPT TO A WIDE VARIETY OF WIRING APPLICATIONS.
- DOOR AND FRONT PANEL ARE REMOVABLE SO CASE CAN BE EASILY MOUNTED TO WALL.
- PLASTIC, LOCKING, UV RESISTANT, WALL-MOUNT CASE.
- 8-, OR 12-STATIONS BASE UNIT EXPANDABLE TO 48 STATIONS WITH 4-, 8-, AND 12-STATION MODULES.
- FLOW SMART MODULE FACTORY INSTALLED OR FIELD UPGRADEABLE.
- LARGE LCD DISPLAY WITH EASY TO NAVIGATE TOUCH USER INTERFACE.
- HOT-SWAPPABLE MODULES, NO NEED TO POWER DOWN THE CONTROLLER TO ADD/REMOVE MODULES.
- DYNAMIC STATION NUMBERING ELIMINATES STATION NUMBERING GAPS.
- WEATHER SENSOR INPUT WITH OVERRIDE SWITCH.
- MASTER VALVE/PUMP START CIRCUIT.
- 6 USER-SELECTABLE LANGUAGES.
- NON-VOLATILE (EED) PROGRAM MEMORY.
- STANDARD 10KV SURGE PROTECTION.
- FRONT PANEL REMOVABLE AND PROGRAMMABLE UNDER BATTERY POWER.
- OPTIONAL FLOW SMART MODULE WITH LEARN FLOW UTILITY AND FLOW USAGE TOTALIZER.
- FLOWATCH PROTECTION FOR HIGH AND LOW FLOW CONDITIONS WITH USER DEFINED REACTIONS.
- FLOWMANAGER MANAGES HYDRAULIC DEMAND, MAKING FULL USE OF AVAILABLE WATER TO SHORTEN TOTAL WATERING TIME.
- SCHEDULES ARE PROGRAMMABLE TO ALLOW UP TO 5 STATIONS TO OPERATE AT THE SAME TIME.
- WATER WINDOWS ARE PROGRAMMABLE TO ALLOW MANUAL MV WATER WINDOW.
- CYCLE-SOAK BY STATION.
- RAIN DELAY.
- 365-DAY CALENDAR DAY OFF.
- PROGRAMMABLE STATION DELAY BY PROGRAM.
- WEATHER SENSOR PROGRAMMABLE BY STATION TO PREVENT OR PAUSE WATERING.
- PROGRAM SEASONAL ADJUST.
- GLOBAL MONTHLY SEASONAL ADJUST.
- ALARM BELL WITH EXTERNAL CASE LENS.
- ELECTRIC DIAGNOSTIC CIRCUIT BREAKER.
- STATION TUNING 9 MINS TO 12 HRS.
- SEASONAL ADJUST: ON TO 300%.
- 4 INDEPENDENT PROGRAMS (ABCD).
- ABCD PROGRAMS CAN OVERLAP.
- 8 START TIMES PER PROGRAM.
- PROGRAM DAY CYCLES W/ USER CUSTOM DAYS OF THE WEEK, 000, 00031, EVEN, & CYCLICAL DATES.
- MANUAL STATION, PROGRAM, TEST PROGRAM.

IRRITROL RFS WIRELESS RAIN/FREEZE SENSOR (OR APPROVED EQUAL)

- COMPATIBLE WITH NEARLY ALL CONTROLLERS.
- VISUAL SENSOR STATUS AND ALERT INDICATORS VERIFY CONSISTENT OPERATION.
- SLIDE/ZIP-ON COVER PROVIDES ADDITIONAL PROTECTION TO WEATHER-PROOF RECEIVER FROM THE ELEMENTS.
- POWER FAILURE MEMORY PROTECTION.
- THREE-YEAR WARRANTY.
- RAIN AND FREEZE SENSORS FULLY INTEGRATED INTO ONE UNIT.
- HIGHLY ACCURATE 4" F DIGITAL ACTIVATION POINT.
- RAIN AND FREEZE SENSORS FULLY INTEGRATED INTO ONE UNIT.
- SENSOR TYPE: INDUSTRY-STANDARD HYDROSCOPIC DISCS.
- RAIN SENSITIVITY: ADJUSTABLE NOMINAL 1/8" TO 3/4".
- OPERATING TEMPERATURE: -20°F TO 120°F.
- HOUSING MATERIAL: UV-RESISTANT ENGINEERED POLYMER.
- WIRELESS ONLY FEATURES:
- TRANSMISSION RANGE: OVER 300 FEET LINE-OF-SIGHT.
- BATTERY: TWO CR2032 3V CELLS, 5-YEAR LIFE (TYPICAL).
- RECEIVER POWER: 22-28 VAC/V dc, 100MA TO BE USED WITH CLASS 2.
- UL-APPROVED (TRANSFORMER).
- LOAD RATING: NORMALLY OPEN OR NORMALLY CLOSED - 3A @24V ac.
- UL LISTED, FCC, CE, IC.

RAIN BIRD PEB SERIES ELECTRIC REMOTE-CONTROL VALVE (OR APPROVED EQUAL)

- 1", 1 1/2", 2"
- DURABLE GLASS-FILLED NYLON CONSTRUCTION FOR LONG LIFE AND RELIABLE PERFORMANCE.
- GLOBE CONFIGURATION.
- NORMALLY CLOSED, FORWARD FLOW DESIGN.
- SLOW CLOSING TO PREVENT WATER HAMMER AND SUBSEQUENT SYSTEM DAMAGE.
- ONE-PIECE SOLID WITH CAPTURED PLUNGER AND SPRING FOR EASY SERVICING.
- PREVENTS LOSS OF PARTS DURING FIELD SERVICE.
- FLOW CONTROL HANDLE ADJUSTS WATER FLOW AS NEEDED.
- MANUAL INTERNAL BLEED OPERATES THE VALVE WITHOUT ALLOWING WATER INTO THE VALVE BOX.
- PRESSURE: 20 TO 200 PSI.
- FLOW: 0.25 TO 200 GPM.
- POWER: 24 VAC.

RAIN BIRD 1800 SERIES POPUP SPRAYHEAD

- 2", 3", 4", 6" AND 12".
- EXCLUSIVE CO-MOLDED SEAL FEATURES AN ENCASED PLASTIC "GAGE" TO PROVIDE UNMATCHED RESISTANCE TO GRIT, PRESSURE AND THE ENVIRONMENT. ADDITIONALLY, THE PRESSURE-ACTIVATED MULTI-FUNCTION SEAL DESIGN ASSURES A POSITIVE SEAL WITHOUT EXCESS "FLOW-BY" WHICH ENABLES MORE HEADS TO BE INSTALLED ON THE SAME VALVE.
- PRECISION CONTROLLED FLUSH AT POP-UP-DOWN CLEARS DEBRIS FROM UNIT, ASSURING POSITIVE STEM RETRACTION IN ALL SOIL TYPES.
- STRONG STAINLESS STEEL SPRING PROVIDES RELIABLE STEM RETRACTION.
- TWO-PIECE RATCHET MECHANISM ON ALL MODELS ALLOWS EASY NOZZLE PATTERN ALIGNMENT AND PROVIDES ADDED DURABILITY.
- PRE-INSTALLED ORANGE 1800 POP-UP FLUSH PLUG BLOCKS DEBRIS FROM ENTERING AFTER FLUSHING, ALLOWING FOR EASY NOZZLE INSTALLATION.
- CONSTRUCTED OF TIME-PROVEN UV-RESISTANT PLASTIC AND CORROSION RESISTANT STAINLESS STEEL PARTS, ASSURING LONG PRODUCT LIFE.
- ALL SPRINKLER COMPONENTS ARE REMOVABLE FROM THE TOP WITHOUT SPECIAL TOOLS, PROVIDING FOR QUICK AND EASY FLUSHING AND MAINTENANCE OF THE SPRINKLER.
- PRESSURE: 15 TO 70 PSI.
- SPACING: 3 TO 20 FEET.
- 1/2" NPT FEMALE THREADED INLET.

SST-PCS 12" PCS RAIN BIRD PRESSURE COMPENSATING SCREEN

- COMPENSATES FOR PRESSURE VARIATIONS.
- ELIMINATES TOPSOIL AND WATER WASTE CAUSED BY HIGH PRESSURES.
- NOZZLES CAN BE MATCHED WITH SCREENS TO CREATE SHORT-THROW, REDUCED-RADIUS PATTERNS AND/OR FLUSH-MOUNTED BUBBLERS.
- COLOR-CODED FOR EASY IDENTIFICATION.
- USE WITH ALL 1800 SERIES PLASTIC NOZZLES (NPR, VAN, U-SERIES, STRIPS, AND BUBBLERS).
- FLOW: 0.10 TO 0.70 GPM.
- PRESSURE: 15 TO 70 PSI.

HUNTER AFB SERIES ADJUSTABLE FLOW BUBBLER (OR APPROVED EQUAL)

- PRESSURE COMPENSATES TO 2.0 GPM FLOW.
- COMPENSATES FOR PRESSURE VARIATIONS.
- NOZZLES CAN BE MATCHED WITH SCREENS TO CREATE SHORT-THROW, REDUCED-RADIUS PATTERNS AND/OR FLUSH-MOUNTED BUBBLERS.
- COLOR-CODED FOR EASY IDENTIFICATION.
- USE WITH ALL 1800 SERIES PLASTIC NOZZLES (NPR, VAN, U-SERIES, STRIPS, AND BUBBLERS).
- FLOW: 0.10 TO 0.70 GPM.
- PRESSURE: 15 TO 70 PSI.

RAIN BIRD QUICK-COUPLING VALVE (OR APPROVED EQUAL)

- RED BRASS CONSTRUCTION FOR LONG LIFE AND RUGGED PERFORMANCE.
- YELLOW THERMOPLASTIC COVER FOR DURABILITY, OPTIONAL LOCKING COVER ON MODELS 330RC, 44RC, AND 54RC (USE 2049 KEY TO UNLOCK), METAL COVER ON MODEL 7 ONLY.
- ONE-PIECE BODY DESIGN MODELS 3RC, 5RC, AND 7.
- TWO-PIECE BODY DESIGN FOR EASY SERVICING MODELS 330RC, 44RC, AND 44RC.
- STRONG CORROSION-RESISTANT STAINLESS STEEL SPRING PREVENTS LEAKAGE.
- PRESSURE: 5 TO 125 PSI.
- FLOW: 10 TO 125 GPM.
- MODELS:
- 3RC: 3/4" RUBBER COVER, 1-PIECE BODY.
- 330RC: 3/4" DOUBLE TRACK KEY LUG, RUBBER COVER, 2-PIECE BODY.
- 44RC: 1" RUBBER COVER, 2-PIECE BODY.
- 44RC: 1" LOCKING RUBBER COVER, 2-PIECE BODY.
- 54RC: 1" RUBBER COVER, 1-PIECE BODY.
- 54RC: 1" LOCKING RUBBER COVER, 1-PIECE BODY.
- 7: 1 1/2" METAL COVER, 1-PIECE BODY.

GENERAL NOTES

PROJECT CONDITIONS

- PERFORM SITE SURVEY, RESEARCH PUBLIC UTILITY RECORDS, AND VERIFY EXISTING UTILITY LOCATIONS. VERIFY THAT IRRIGATION SYSTEM PIPING MAY BE INSTALLED IN COMPLIANCE WITH ORIGINAL DESIGN AND REFERENCED STANDARDS.

WATER SOURCE

- INSTALLER SHOULD CONFIRM THE MINIMUM DISCHARGE REQUIREMENTS OF THE WATER SOURCE AS INDICATED ON THE DRAWING LEGEND PRIOR TO INSTALLATION.
- IF SOURCE IS LESS THAN MINIMUM REQUIREMENT, CONSULT WITH A DESIGNER FOR POSSIBLE HYDRAULIC CHANGES.

BACKFLOW PREVENTER

- DESIGN UTILIZES AN INLINE DOUBLE CHECK BACKFLOW PREVENTER DEVICE. INSTALLER MUST CONFIRM WITH THE LOCAL WATER AUTHORITY THEIR APPROVED TYPE DEVICE AND INSTALLATION METHODS IN ORDER TO CONFORM WITH LOCAL CODES. IF A DIFFERENT TYPE DEVICE IS USED, CONSULT WITH A DESIGNER FOR POSSIBLE HYDRAULIC CHANGES.

SLEEVING

- A MINIMUM OF PR-200 PVC SLEEVES SHOULD BE USED UNDER ANY HARDSCAPING. (EXAMPLE: SIDEWALKS AND DRIVEWAYS)
- SLEEVES TO BE A MINIMUM OF (2) PIPE SIZES LARGER THAN THE PIPE RUNNING THROUGH IT.
- A SEPARATE SLEEVE IS RECOMMENDED FOR WIRE.
- WHERE MAINLINE AND WIRE ARE ROUTED THROUGH A COMMON SLEEVE/BORE, WIRE TO BE INSTALLED IN A SEPARATE INLET CONDUIT.

PIPE AND FITTINGS

- ALL PIPE 1" OR SMALLER TO BE PR-200 SDR-21 SOLVENT WELD PVC PIPE.
- ALL PIPE 1 1/4" OR LARGER TO BE PR-160 SDR-26 SOLVENT WELD PVC PIPE.
- ALL PVC PIPE FITTINGS TO BE SCHEDULE 40, SOCKET-TYPE.
- PVC PIPING AND FITTINGS SOLVENT-CEMENTED JOINTS TO BE CONSTRUCTED UTILIZING CLEANER, PURPLE PRIMER, AND SOLVENT CEMENTS.
- GENERAL LOCATIONS AND ARRANGEMENTS: DRAWINGS INDICATED GENERAL LOCATION AND ARRANGEMENT OF PIPING SYSTEMS. INDICATED LOCATIONS AND ARRANGEMENTS WERE USED FOR DESIGN LEGIBILITY, TO SIZE PIPE AND CALCULATE FRICTION LOSS, AND OTHER DESIGN CONSIDERATIONS.
- MINIMUM COVER: PROVIDE THE FOLLOWING MINIMUM COVER OVER TOP OF BURIED PIPING OR 12" BELOW THE AVERAGE LOCAL FROST DEPTH, WHICHEVER IS THE GREATER DEPTH.
- PRESSURE PIPING: 18" OF COVER FOR PIPE 2 1/2" AND SMALLER; 24" FOR PIPE 3" AND 4", AND 30" FOR PIPE 6" AND LARGER.
- CIRCUIT PIPING: 18" OF COVER FOR CIRCUIT PIPE.
- DRAIN PIPING: 18" OF COVER FOR PIPE 4" AND SMALLER; 24" FOR PIPE 6" AND LARGER.
- SLEEVES: 24" OF COVER FOR PIPE 6" AND SMALLER; 30" FOR PIPE 8" AND LARGER.
- PRIOR APPROVAL BY LANDSCAPE ARCHITECT MUST BE OBTAINED FOR ALL TRENCHING AROUND EXISTING SPECIMEN/LARGE TREES.
- ONLY HAND TRENCHING WILL BE ALLOWED WITHIN THE "TREE SAVE" AREAS.

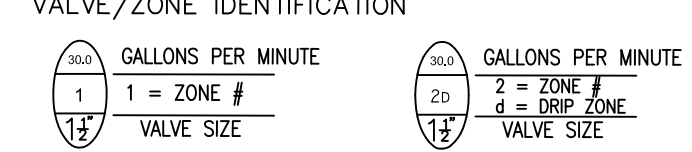
SCHEDULING

- ADJUST SETTINGS OF CONTROLLERS AND AUTOMATIC CONTROL VALVES, AND PROVIDE WRITTEN SCHEDULE TO OWNER.

WIRING

- SOLID COPPER CONDUCTOR, INSULATED CABLE, SUITABLE FOR DIRECT BURIAL.
- LOW-VOLTAGE, BRANCH CIRCUIT CABLES: TYPE PL NO. 14 AWG MINIMUM.
- BETWEEN CONTROLLERS AND AUTOMATIC CONTROL VALVES, JACKET COLOR IS OTHER THAN FEEDER-CIRCUIT-CABLE JACKET COLOR.
- SPRING MATERIALS: 3M DBRY OR APPROVED EQUAL.

VALVE/ZONE IDENTIFICATION



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3	S.C.	COLLETON	0041932	02-14011	SC 63		

CITY OF WALTERBORO (02/12/16)
Equipment List – By Roman Fountains

Item No.	Qty.	Component Number	Description
01	1	CSR-196 (Special)	16'-4" Dia. Copper Spray Ring
02	1	RCN-200	2" Cascade Nozzle
*03	7	RWS-200-S	2" Slab Penetration Fitting
*04	2	RAVS-1600	16" Sq. Anti-Vortex Plate and Sump Assembly
*05	1	RFD-300	3" Machined Cast Bronze Floor-Drain Fitting
*06	1	RCOM-WND	Overflow/Low Water Level Sensor
07	16	RFL-CG-FS-LED-W	Freestanding LED Submersible Light Fixture
08	4	RJB-4-100-C	Submersible Junction Box
*09	4	RWS-100-L	1" Slab Penetration Fitting
10	4	RPC-2114-D	Potting Compound
11	1	RWC-A-DUL	Anemometer
*12	2	RPS-150-FA-WIS	Front Access Surface Skimmer W/Waterstop
*13	2	REF-150-WS	Adjustable 'Eyeball' Inlet Fitting
14	1	RDP-2H-750 (Special)	Series 2H Direct Bural Pump Vault PWR. RQT: 120/208V 3-Phase
15	2	RPVC-600	6" PVC Vent Cap

*NOTE: CONCRETE EMBED ITEM, REQUIRED FOR POUR.
 *NOTE: SEE SHEET WFN-2 FOR FULL ITEM DESCRIPTIONS.



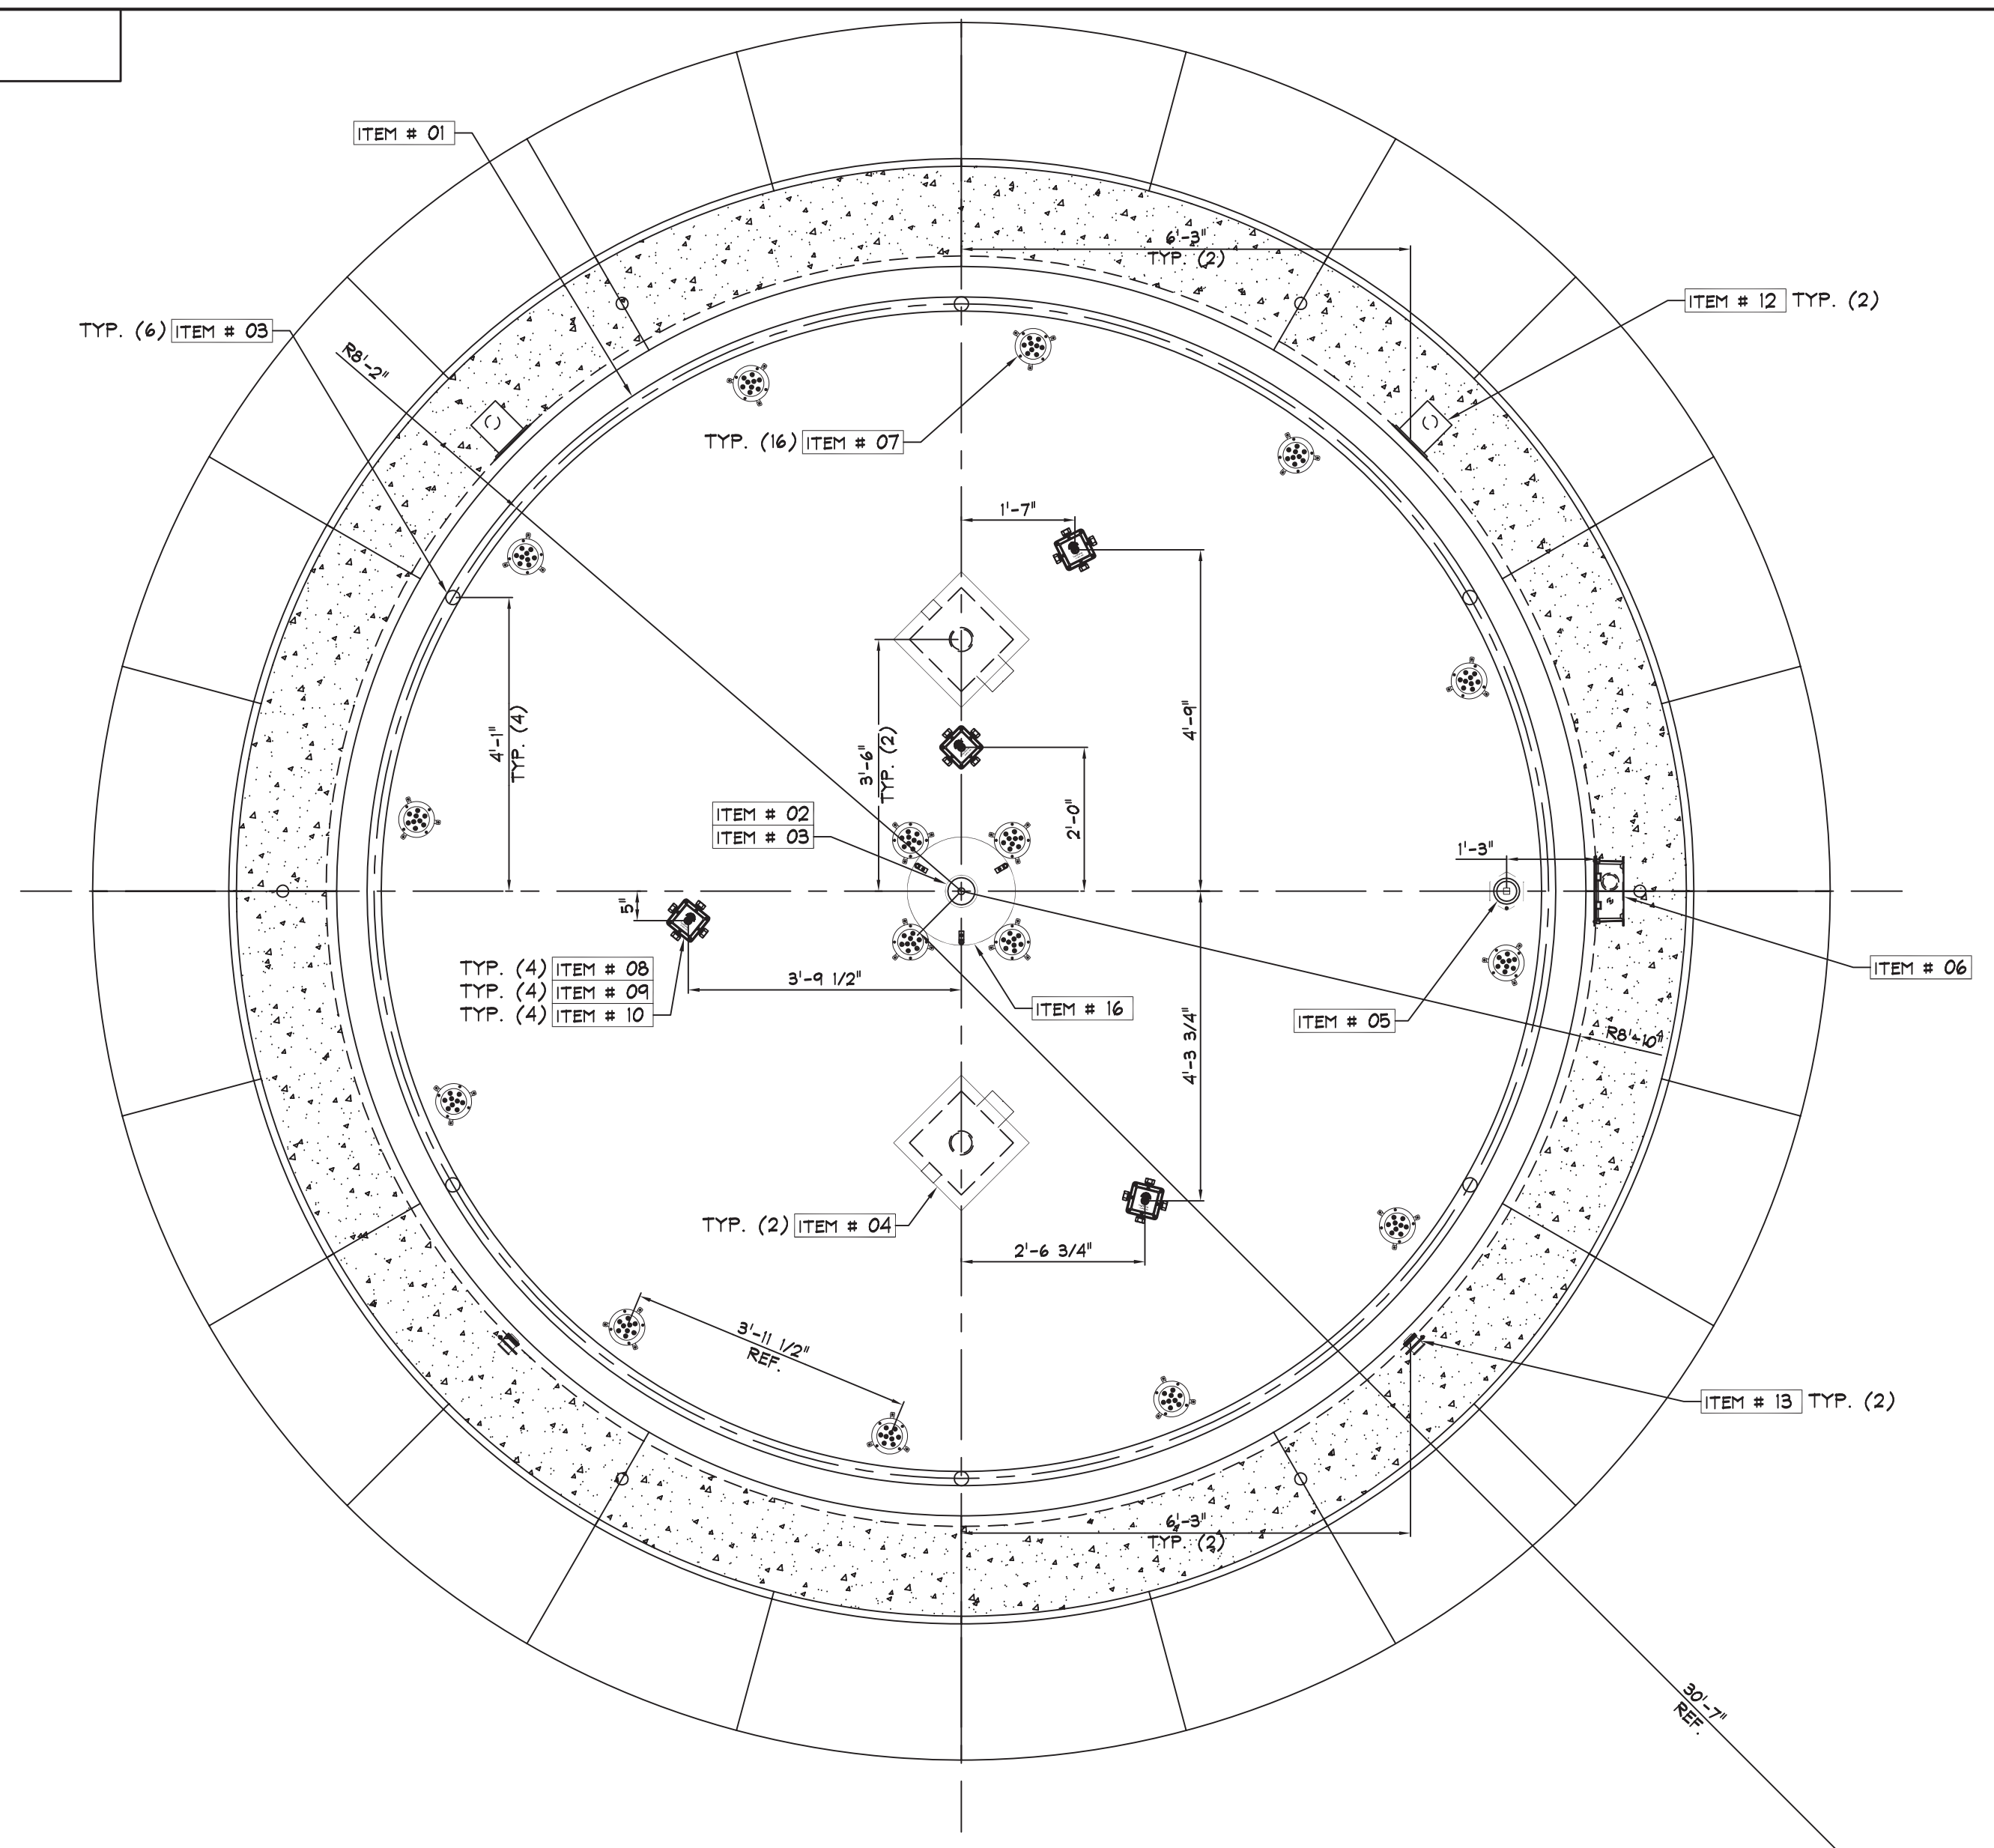
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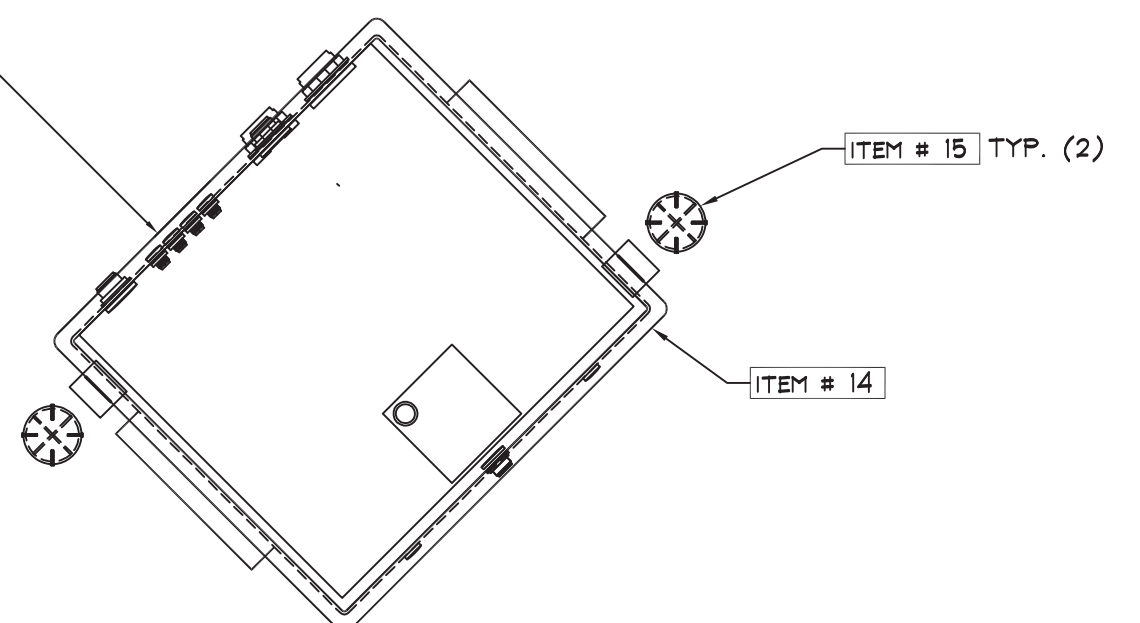
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SHEET NUMBER
L23



NOTE:
 INSTALL ANEMOMETER WITHIN 200 FT. OF WIND CONTROL PANEL IN AN OPEN AREA THAT WILL EXPERIENCE THE SAME WIND CURRENTS AS THE WATER FEATURE.

NOTE:
 INSTALLER TO COORDINATE EXACT LOCATION OF PUMP VAULT WITH LANDSCAPE ARCHITECT.



FOUNTAIN DIMENSION PLAN
 SCALE: 1/2"=1'-0"

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FOUNTAIN DIMENSION PLAN



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*05	1	RFD-300	3" Machined Cast Bronze Floor-Drain Fitting
*06	1	RCOM-WND	Overflow/Low Water Level Sensor
07	16	RFL-CG-FS-LED-W	Freestanding LED Submersible Light Fixture
08	4	RJB-4-100-C	Submersible Junction Box
*09	4	RWS-100-L	1" Slab Penetration Fitting
10	4	RPC-2114-D	Potting Compound
11	1	RWC-A-DUL	Anemometer
*12	2	RPS-150-FA-WS	Front Access Surface Skimmer W/Waterstop
*13	2	REF-150-WS	Adjustable 'Eyeball' Inlet Fitting
14	1	RDP-2H-750 (Special)	Series 2H Direct Burial Pump Vault PWR ROT-120/20V, 3-Phase
15	2	RPVC-600	6" PVC Vent Cap

NOTE: CONCRETE EMBED ITEM, REQUIRED FOR POUR.
NOTE: SEE SHEET WFN-2 FOR FULL ITEM DESCRIPTIONS.



PREPARED FOR:
95% PLANS
I-95 BUSINESS LOOP PHASES 1B
 Walterboro, South Carolina


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SHEET NUMBER
L25




IMPORTANT NOTE:
 INSTALL PIPING IN EQUIDISTANT LENGTHS WHERE INDICATED, TO PROVIDE BALANCED FLOW DISTRIBUTION.


PIPING SCHEMATIC SYMBOL LEGEND

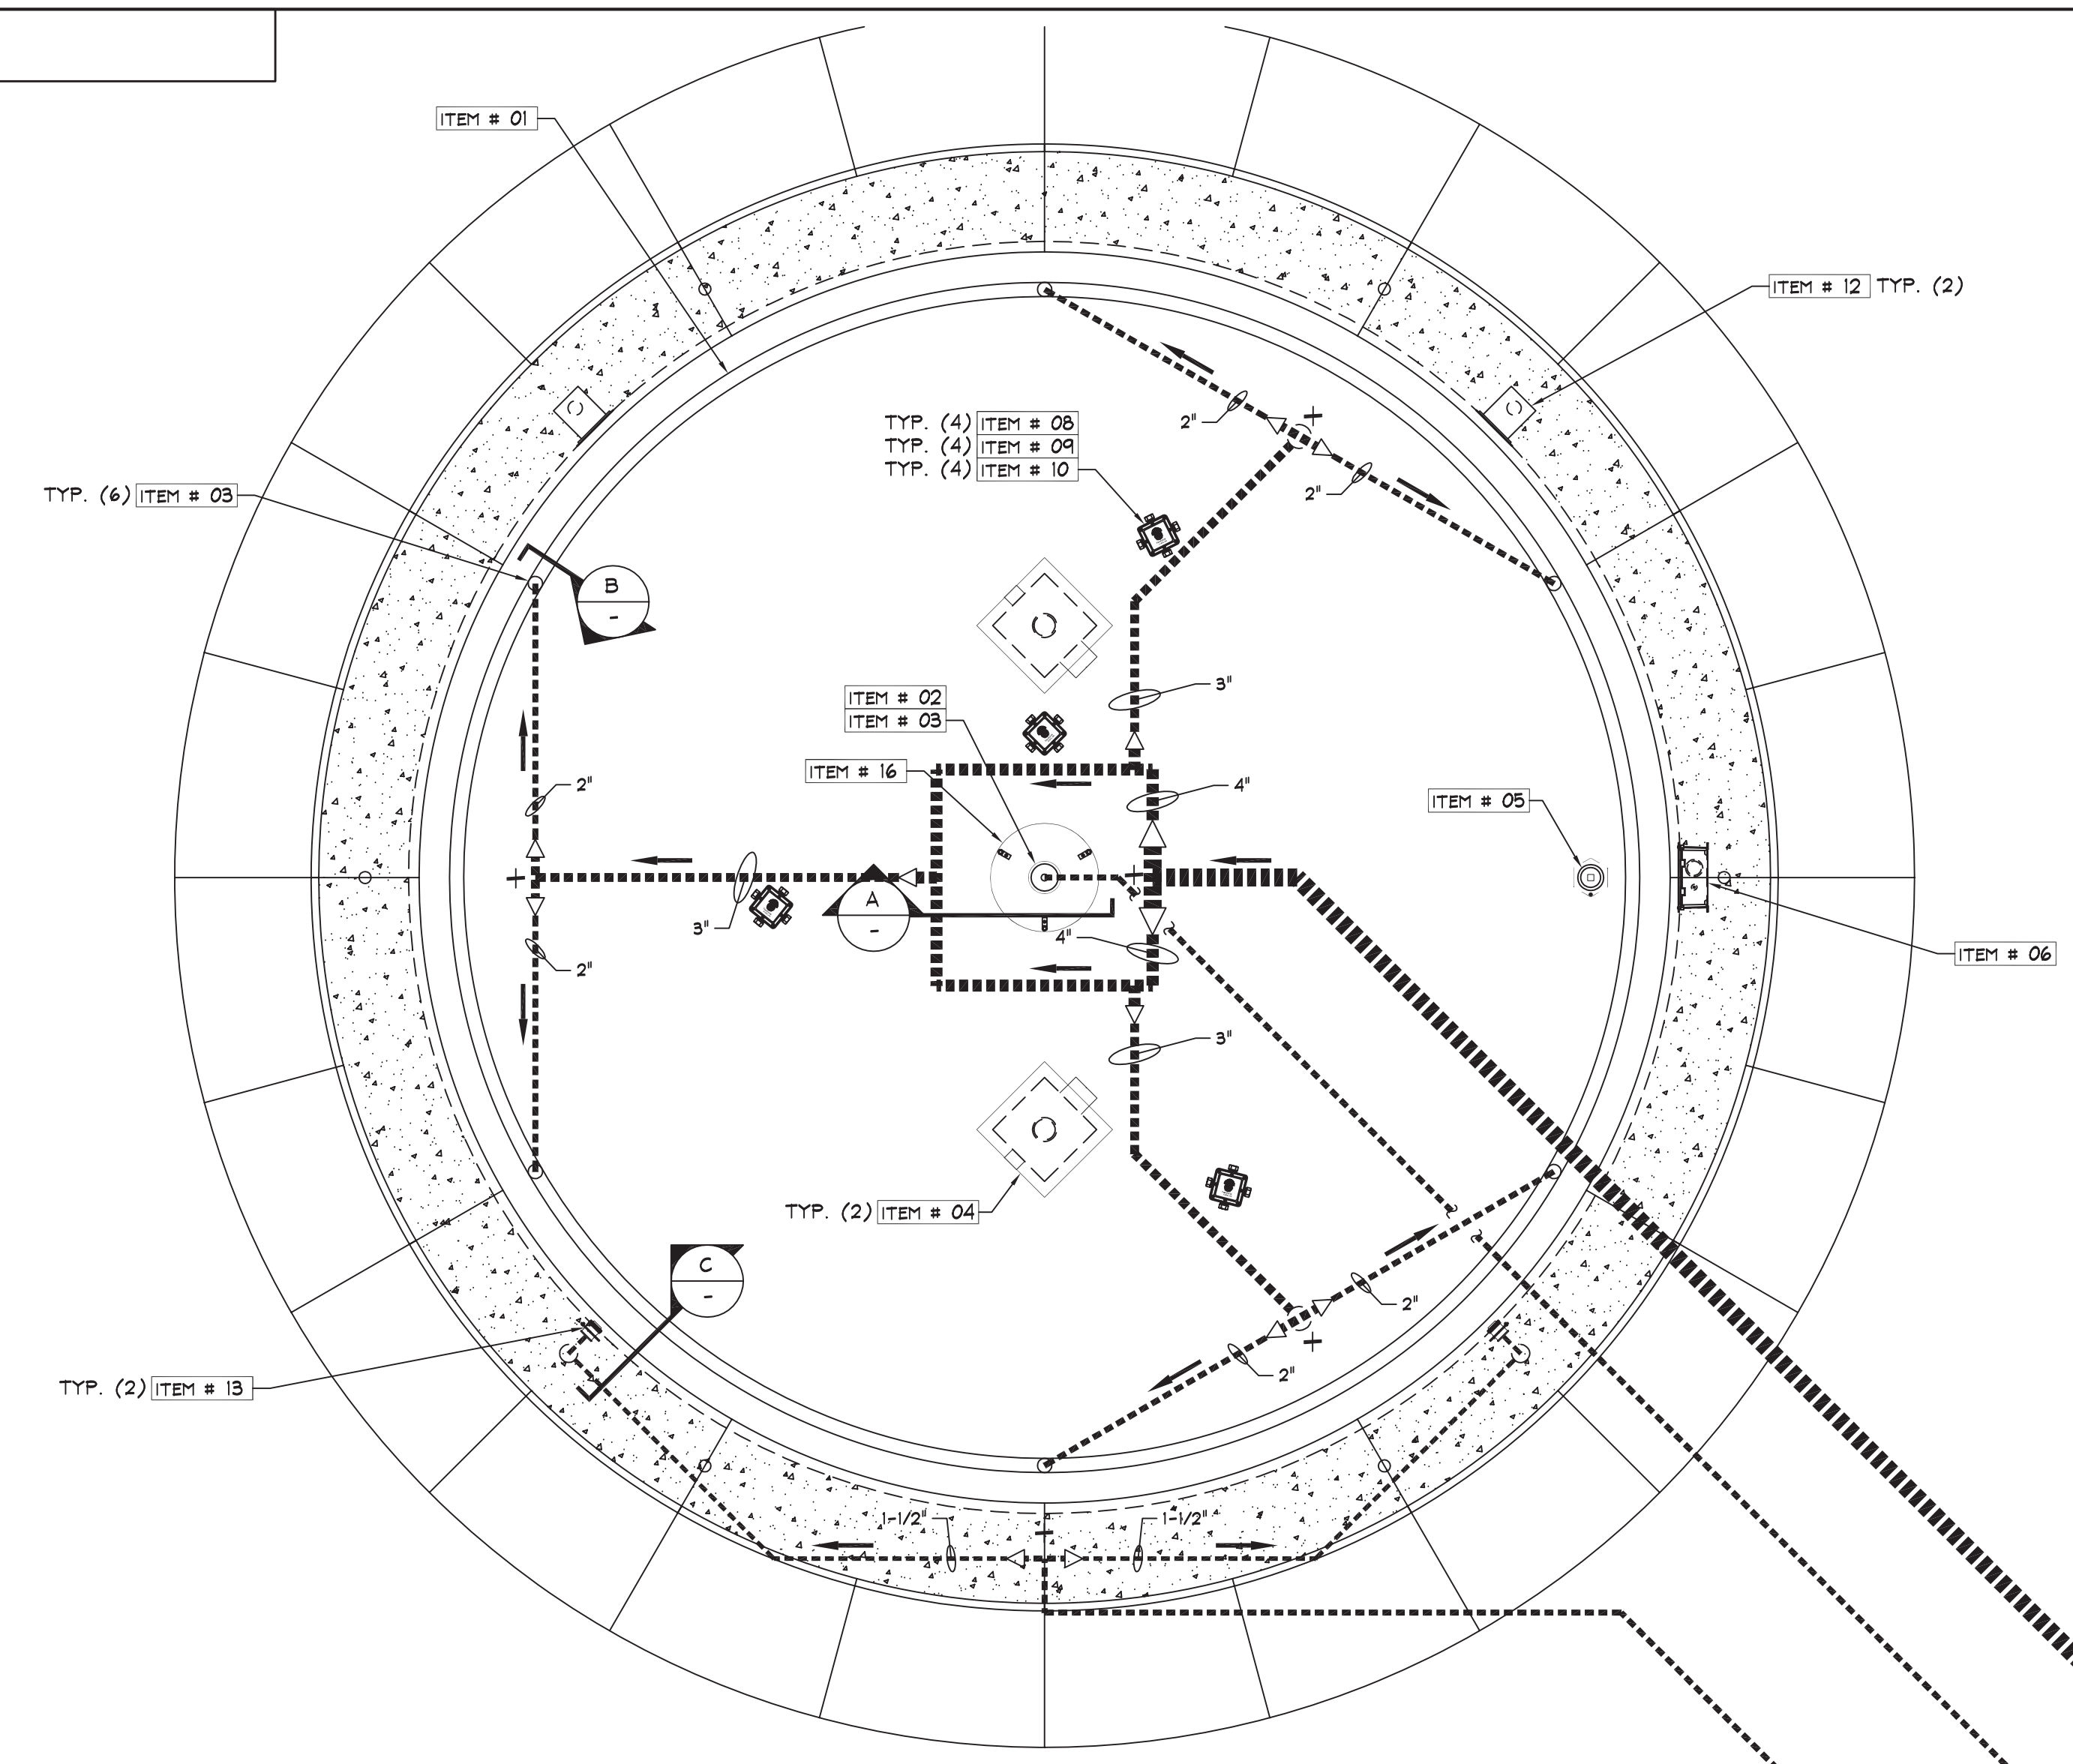- Symbol Description
- > A reducer fitting, by installer, is required at this location to change the pipe size.
- > Piping turning downward in plan view via a 90 degree elbow. This allows another 90 degree elbow, located directly below the shown schematic elbow, to change the pipe direction to any angle.
- > Piping turning downward in plan view or directly away from the viewer in section view via a 90 degree elbow.
- > Piping turning upward in plan view or directly towards the viewer in section view via a 90 degree elbow.
- > Direction of water flow.

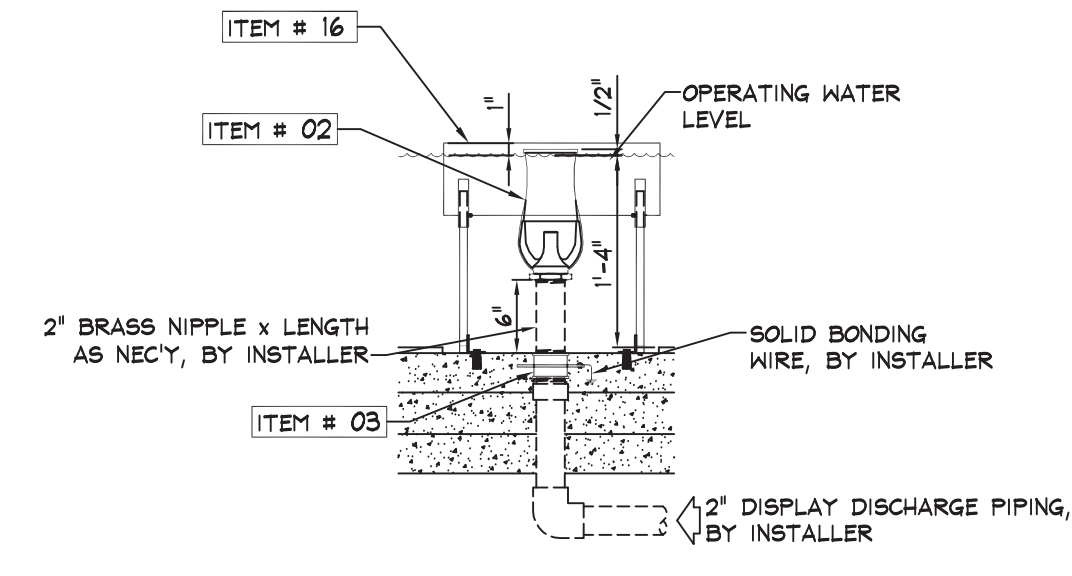
FOUNTAIN DISCHARGE & FILL PIPING PLAN
 SCALE: 1/2"=1'-0"



SECTION 'A'
 SCALE: 3/4"=1'-0"

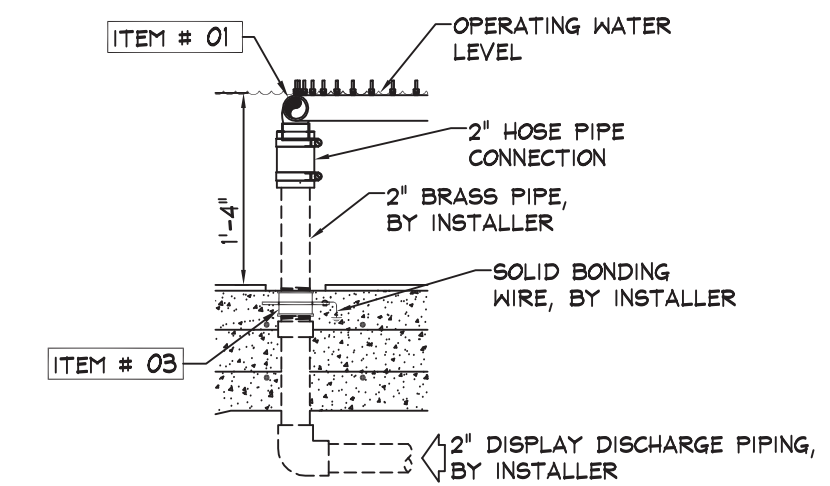

SECTION 'B'
 SCALE: 3/4"=1'-0"

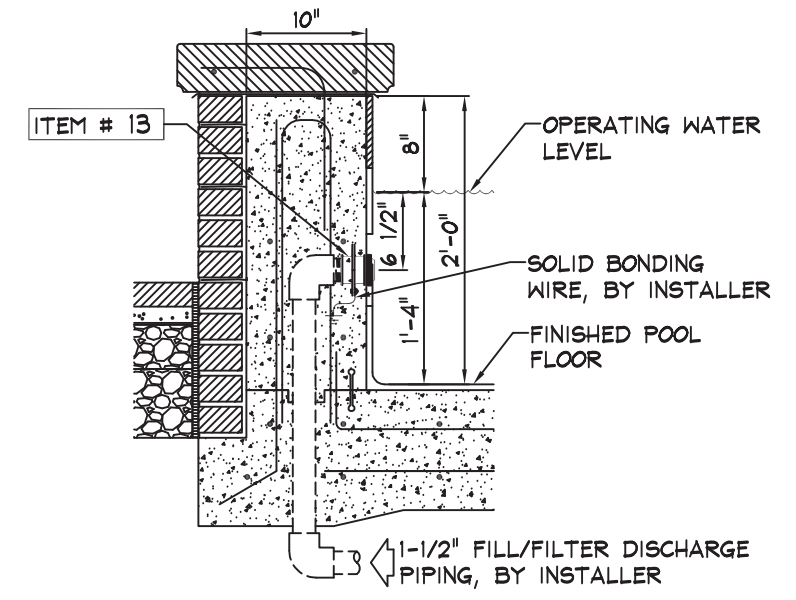

SECTION 'C'
 SCALE: 3/4"=1'-0"

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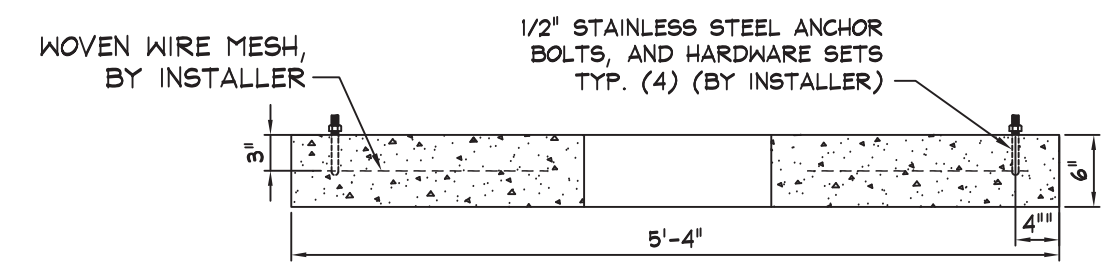
ROMAN FOUNTAINS
 FOUNTAIN DISCHARGE & FILL PIPING PLAN



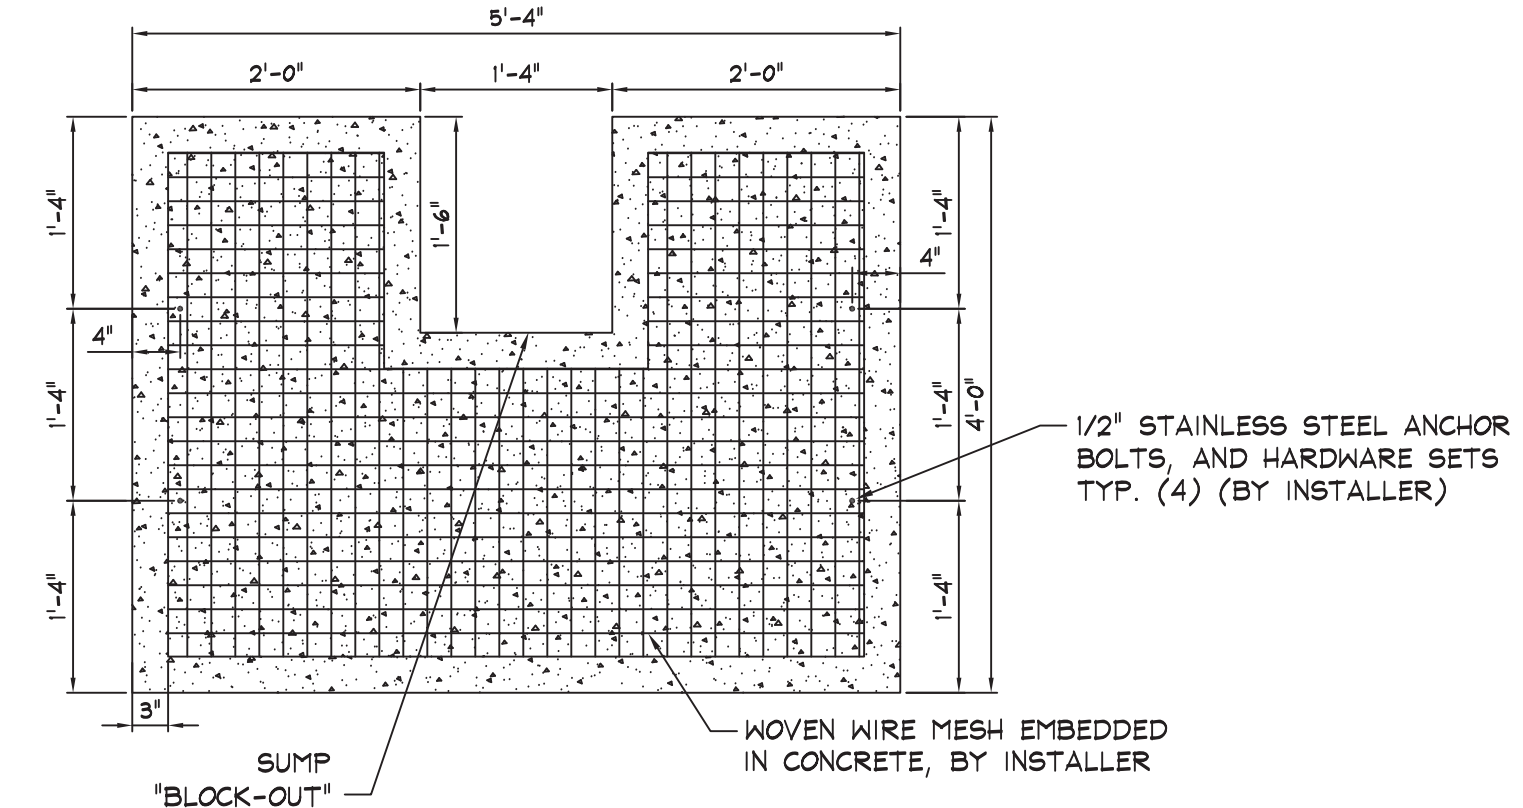
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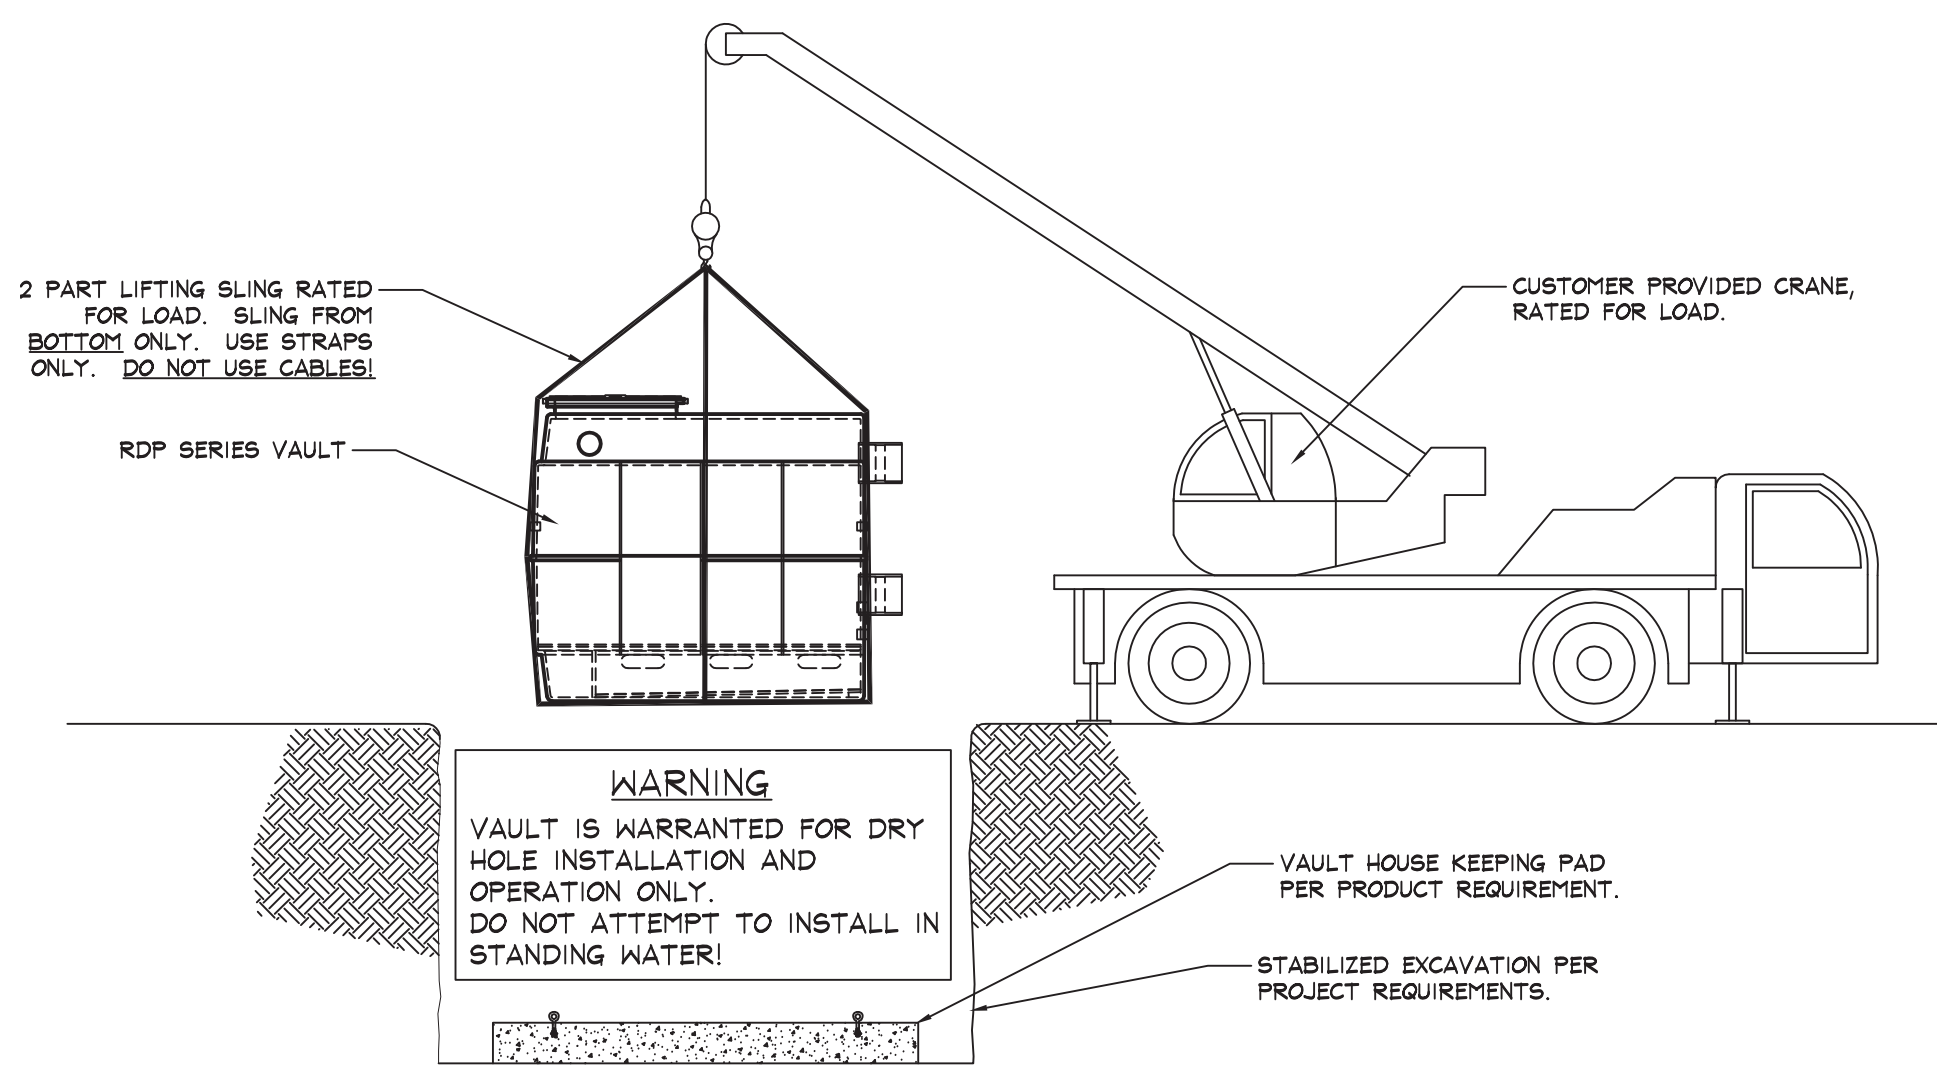
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SERIES 2/2H VAULT PAD SECTION (W/SUMP)
SCALE: 3/4"=1'-0"



SERIES 2/2H VAULT PAD PLAN (W/SUMP)
SCALE: 3/4"=1'-0"



VAULT BEING REMOVED FROM TRUCK



VAULT OFF-LOADED FROM TRUCK

NEC ARTICLE 680.11 NOTICE
EQUIPMENT ROOMS, VAULTS AND PITS MUST HAVE ADEQUATE DRAINAGE TO PREVENT WATER ACCUMULATION DURING NORMAL OPERATION OR FILTER USE. INSTALLER SHALL CONNECT A DRAIN LINE TO DRAIN FITTING FURNISHED ON VAULT AND TERMINATE IT IN ACCORDANCE WITH LOCAL CODES.

GROSS WEIGHT OF VAULT


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<input type="checkbox"/> RDP-2 Series	1,000 LBS
<input checked="" type="checkbox"/> RDP-2H Series	1,500 LBS
<input type="checkbox"/> RDP-3S Series	2,000 LBS
<input type="checkbox"/> RDP-3 Series	3,000 LBS
<input type="checkbox"/> RDP-4 Series	5,000 LBS
<input type="checkbox"/> RDP-5 Series	10,000 LBS



VAULT IN POSITION PROTECTED BY 'CAVE-IN' BARRIER



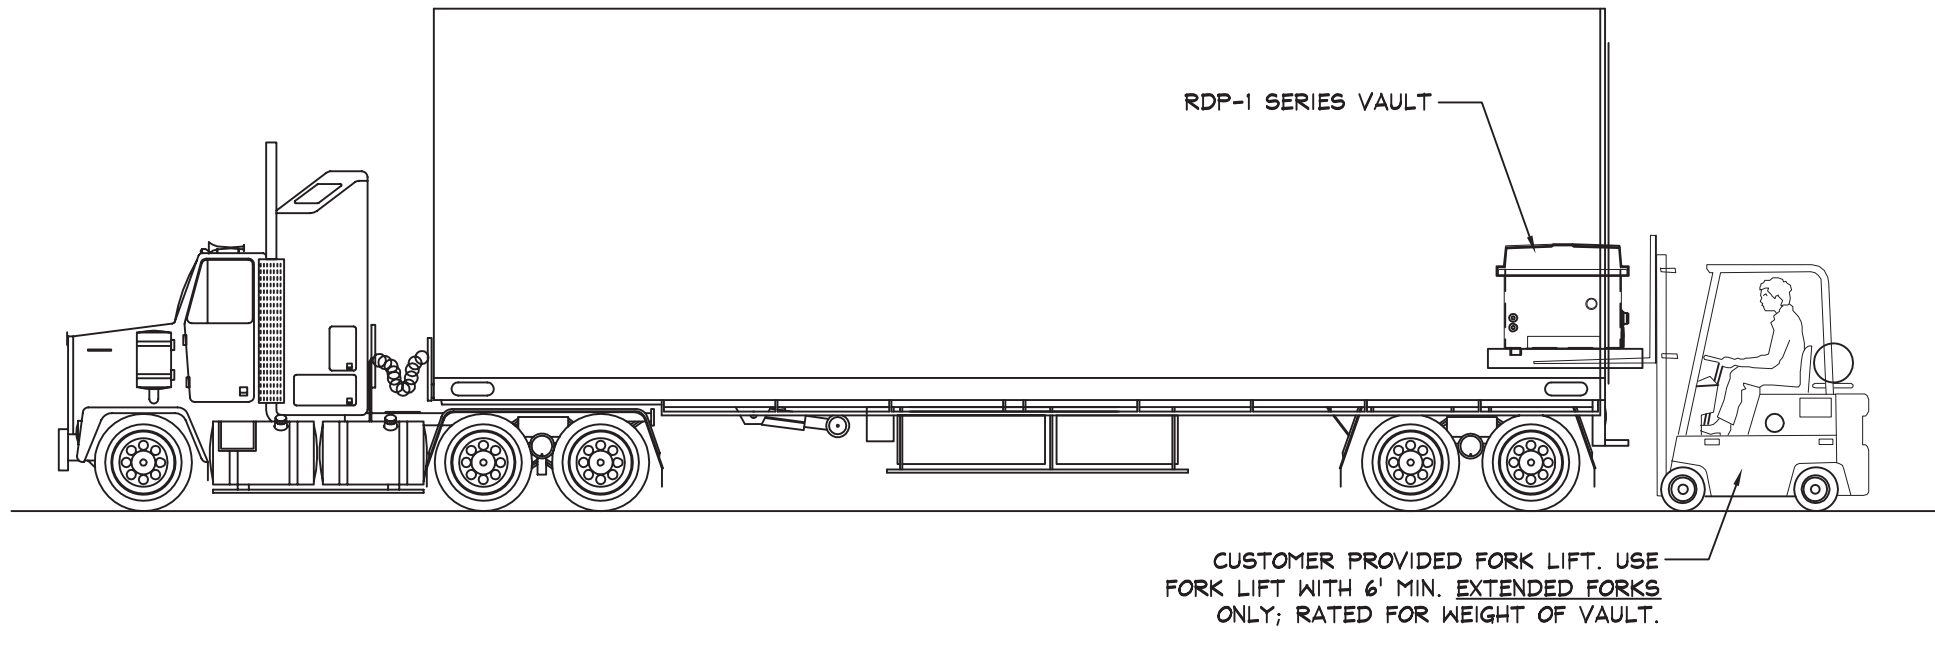LIFTING FORK CRANE WITH DOUBLE STRAP SLING



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COMMON NOTES FOR SERIES 2/2H WITH & W/O SUMP:
RECOMMENDED MINIMUM SLAB REINFORCEMENT REQUIREMENTS:
- INSTALLER TO USE #6 X 6-4 WOVEN WIRE MESH. INSTALL WITH MINIMUM 3" CLEARANCE ON ALL SIDES.
THIS INFORMATION INDICATES SUGGESTED MINIMUMS ONLY. INSTALLER TO CONSULT AND ADHERE TO STATE AND LOCAL CODES FOR CONCRETE SPECIFICATION REQUIREMENTS, SLAB DIMENSIONS & THICKNESS AND REINFORCING STRUCTURES.

- NOTES:**
- HATCHWAY OPENING MUST BE LOCATED IN A AREA SAFE FROM FLOODING; SLOPE GRADE AWAY FROM VAULT.
 - PROTECT THE FURNISHED DRAIN LINE FROM POSSIBLE BACKFLOW AND SEWER GAS, AS REQUIRED.
 - VAULT SUCTION INTAKE MUST BE MIN. 1'-0" BELOW THE LOWEST POOL OPERATING WATER LEVEL.
 - ALL VAULT AND PENETRATIONS ARE APPROXIMATE.

***ALL INTERCONNECTING PIPE, FITTINGS, CONDUIT, ETC. ARE BY INSTALLER**

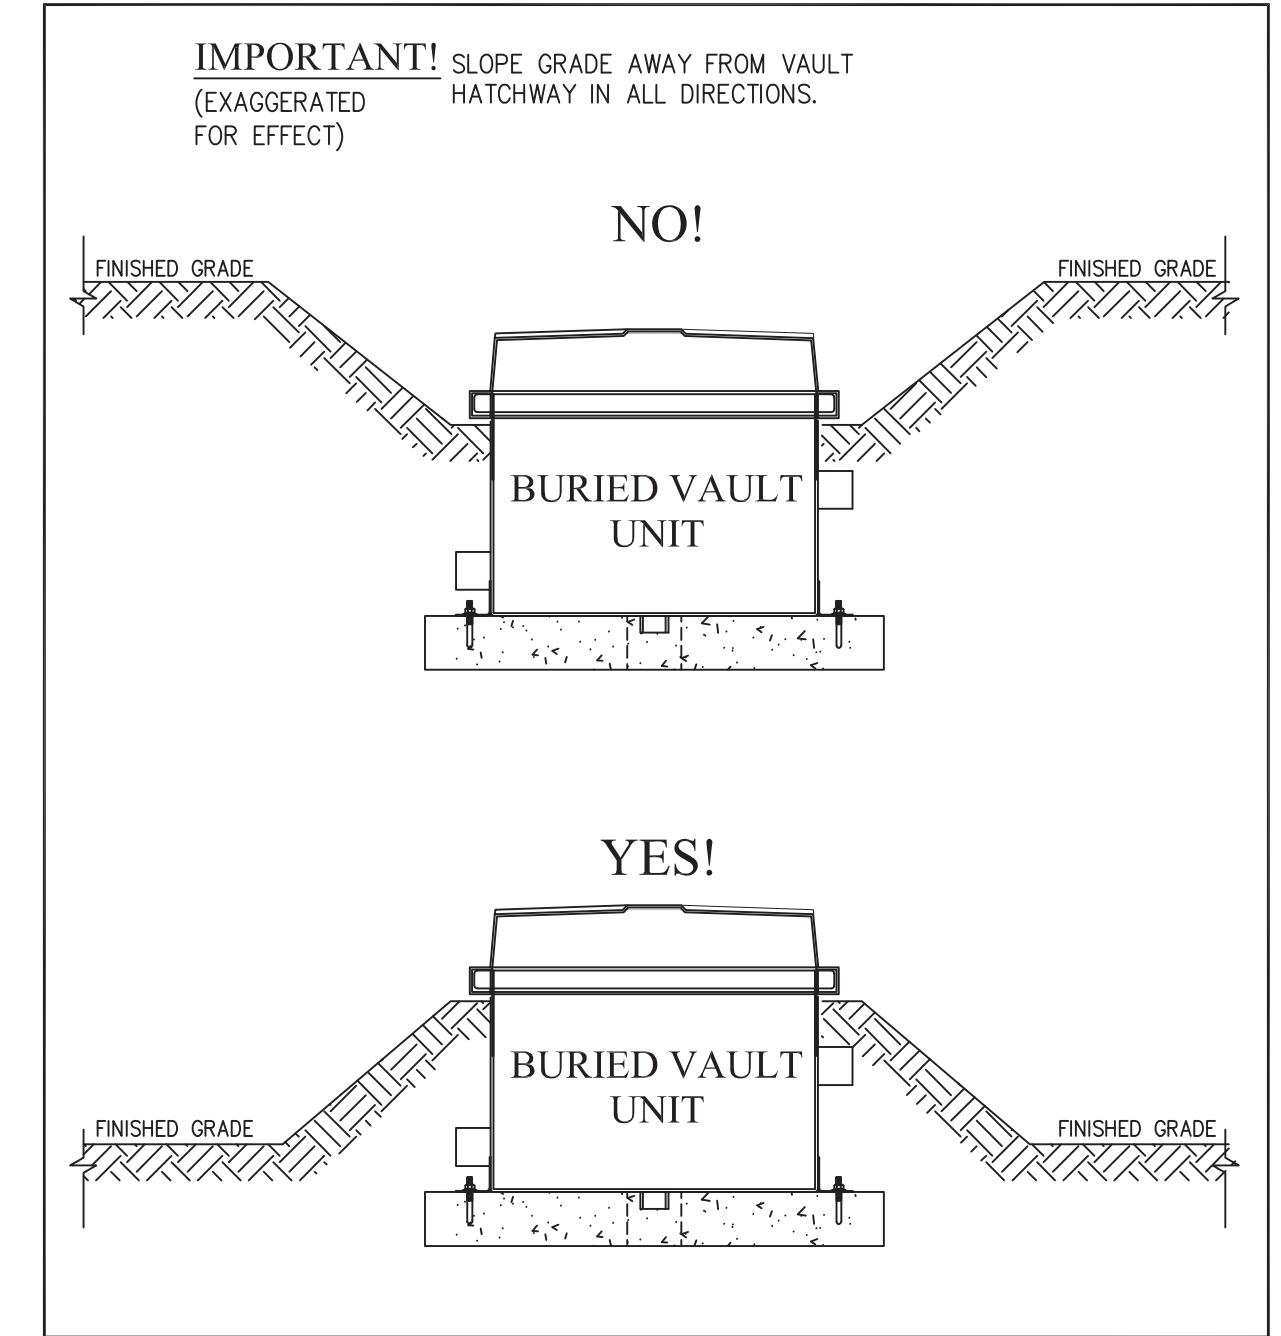
CAUTION: INSTALLER TO VERIFY THAT ELEVATIONS AND OTHER DIMENSIONAL INFORMATION PROVIDED HEREIN, AGREE WITH ACTUAL SITE CONDITIONS. PLEASE REPORT ANY DEVIATIONS, OR POTENTIAL INSTALLATION CHANGES IMMEDIATELY TO ROMAN FOUNTAINS. PHONE: (505) 343-8082.
NOTE: THE PROPER DESIGN, OPERATION AND PERFORMANCE OF THIS SYSTEM IS BASED ON THE SELECTION AND USE OF EQUIPMENT MANUFACTURED AND/OR SELECTED BY ROMAN FOUNTAINS CORPORATION, ALBUQUERQUE, NEW MEXICO, U.S.A.; PHONE: (505) 343-8082. SUBSTITUTION OF EQUIPMENT OTHER THAN THAT SELECTED AND FURNISHED, VOIDS THE SYSTEM WARRANTY AND PERFORMANCE GUARANTEE, AND INSTALLER ASSUMES FULL RESPONSIBILITY FOR ITS OPERATION AND PERFORMANCE.

⚡ DANGER ⚡
FATAL ELECTRICAL SHOCK CAN OCCUR IF FOUNTAIN ELECTRICAL EQUIPMENT IS NOT INSTALLED PROPERLY. THIS EQUIPMENT SHOULD ONLY BE INSTALLED BY QUALIFIED ELECTRICIANS WITH PROPER GROUNDING AND GROUND FAULT INTERRUPTION CIRCUIT BREAKERS IN ACCORDANCE WITH NATIONAL ELECTRICAL CODE, SECTION 680, AND ALL OTHER APPLICABLE SECTIONS OF THE CODE.

NOTICE
THIS VAULT PRODUCT IS NOT OFFERED AS A 'UL' OR 'ETL' LISTED ASSEMBLY. SHOULD THE LOCAL INSPECTING AUTHORITY HAVING JURISDICTION (AHJ) REQUIRE SUCH A LISTING THE CUSTOMER SHALL BEAR ALL RESPONSIBILITY FOR OBTAINING SUCH A LISTING.
UL CAN BE CONTACTED AT UL CUSTOMER SERVICE (877) 854-3577 OR VIA E-MAIL AT ULFieldinspections@UL.com TO REQUEST/SCHEDULE AN ON-SITE FIELD INSPECTION.
ANY AND ALL COSTS AND POSSIBLE CONSTRUCTION DELAYS ASSOCIATED WITH SAID FIELD INSPECTION SHALL BE THE RESPONSIBILITY OF THE CUSTOMER AND NOT ROMAN FOUNTAINS.

CAUTION
"ALL VAULT DIMENSIONS, PENETRATIONS AND SLEEVE LOCATIONS ARE APPROXIMATE."
IF FINAL INSTALLATION TOLERANCES/ELEVATIONS/LOCATIONS/POSITIONS ARE CRITICAL INSTALLER SHALL CONTACT ROMAN FOUNTAINS PRIOR TO FINALIZING TRENCHING DEPTHS, EXCAVATION AND ANCHOR SLAB POUR FOR CERTIFICATION OF ACTUAL FINISHED VAULT DIMENSIONS."

CAUTION
ANY AND ALL VOIDS, POCKETS AND 'DEAD AIR SPACE' BENEATH A DIRECT BURIAL PUMP VAULT UNIT 'MUST' BE COMPLETELY FILLED IN AND ADEQUATELY COMPACTED PRIOR TO FINAL BACKFILLING AROUND VAULT UNIT. USE A PROPERLY FORMULATED, LOW CEMENTITIOUS CONTENT 'FLOWABLE FILL' MIXTURE OR OTHER FREE FLOWING MATERIAL TO COMPLETELY FILL ALL VOIDS, AS SPECIFIED AND APPROVED BY THE PROJECT ENGINEER.



WARNING:
DIRECT-BURIAL PUMP VAULTS ARE DESIGNED AND CONSTRUCTED FOR 'DRY-HOLE' INSTALLATIONS ONLY AND ARE NOT DESIGNED, CONSTRUCTED, OR SOLD AS WATERTIGHT OR WATERPROOF CONTAINERS AND ARE NOT TO BE INCORPORATED INTO ANY PROJECT WHERE POTENTIAL GROUND WATER SATURATION (WHETHER TEMPORARY OR PERMANENT OR DUE TO RAIN, FLOODS OR IRRIGATION) OR NATURAL GEOLOGICAL HIGH WATER TABLE CONDITIONS MAY EXIST.
AS SUCH, ROMAN FOUNTAINS IS NOT RESPONSIBLE FOR ANY GROUNDWATER INTRUSION INTO ANY FIBERGLASS EQUIPMENT VAULT UNDER ANY CIRCUMSTANCES WHATSOEVER.
THE SPECIFIER/PURCHASER/INSTALLER/OWNER OF ANY VAULT PRODUCT SHALL MAKE ANY AND ALL DETERMINATIONS AS TO THE SUITABILITY OF SAID PRODUCT FOR THE APPLICATION, INCLUDING GROUND WATER CONDITIONS.



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RDP-2H-500 DIRECT BURIAL PUMP VAULT DETAILS #2



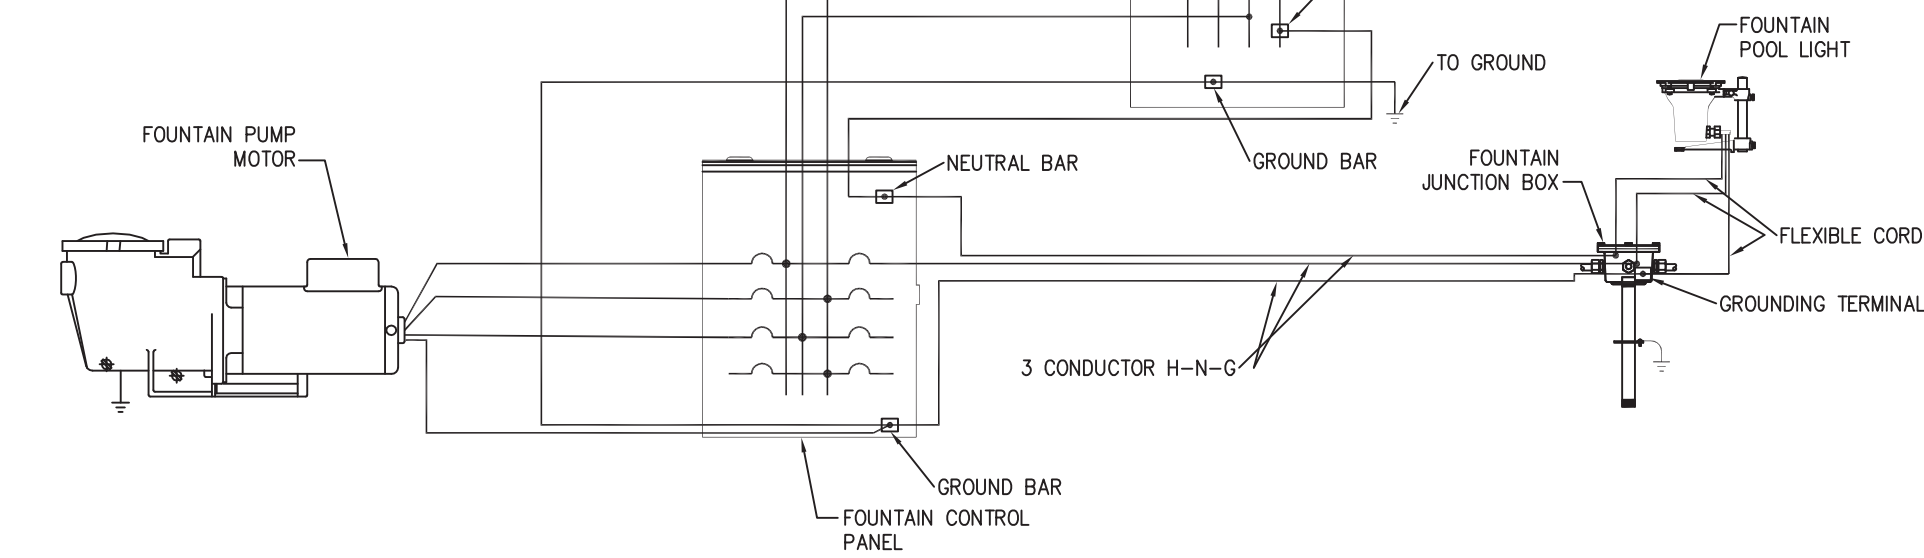
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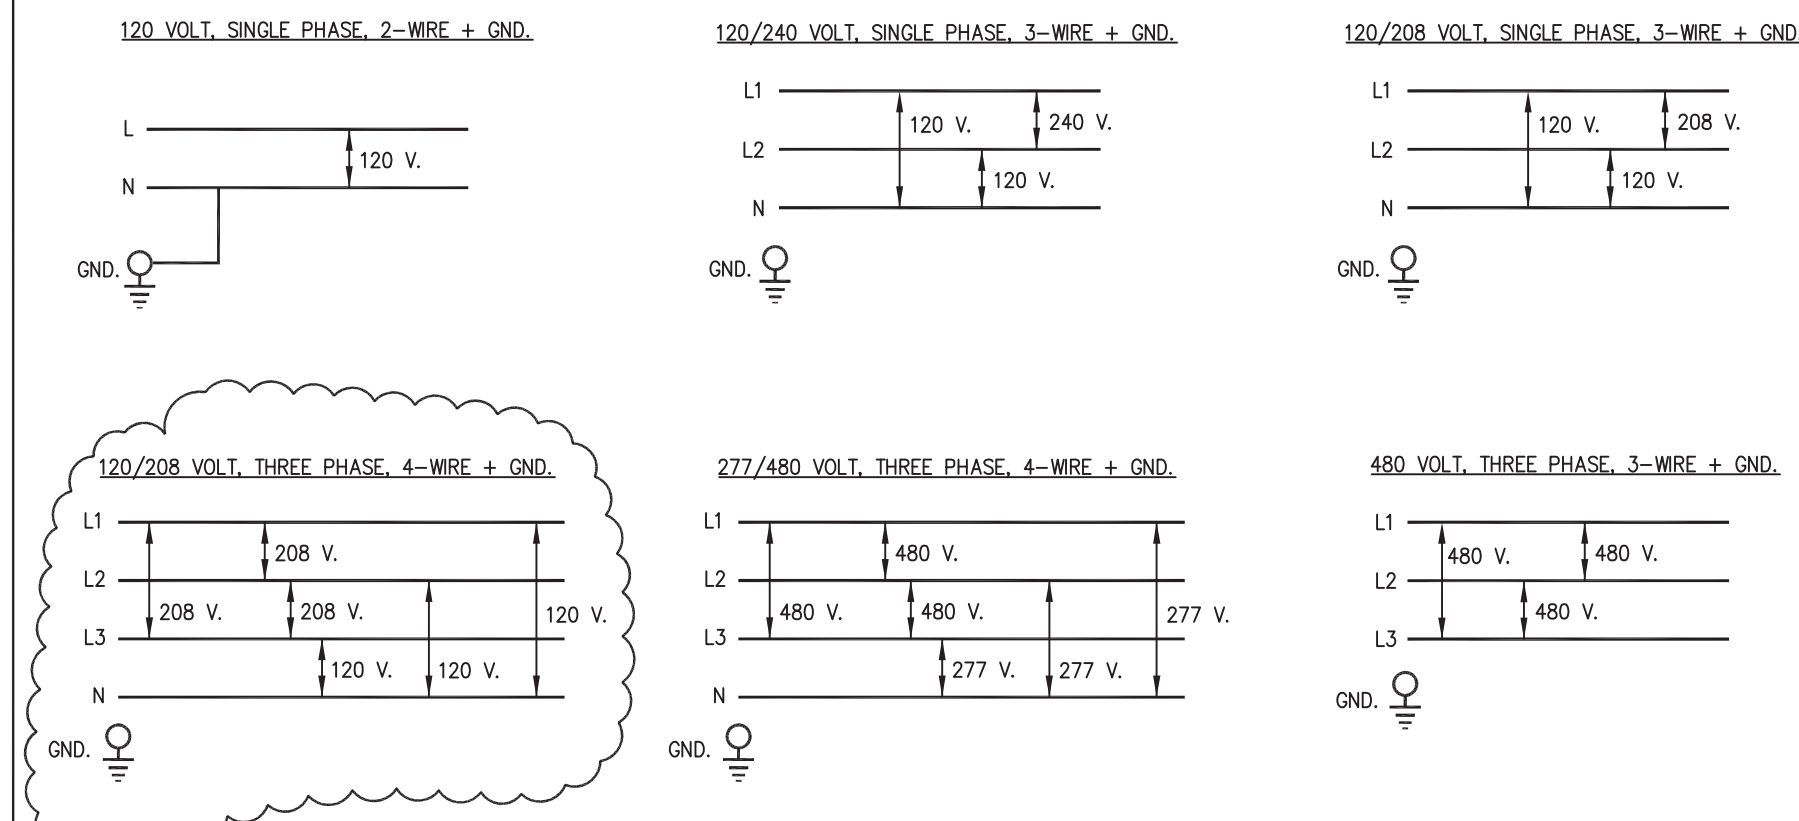
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3	S.C.	COLLETON	0041932	02-14011	SC 63		

- "GROUNDING" CONSISTS OF GROUNDING ELECTRICAL DEVICES.
1. ALL FOUNTAIN ELECTRICAL EQUIPMENT MUST BE GROUNDED PER NEC 680.
 2. GROUND WIRE IS EITHER PART OF A SUBMERSIBLE CABLE, INSIDE A CONDUIT, OR INSIDE AN ELECTRICAL ENCLOSURE.
 3. FOUNTAIN CONTROL PANELS ARE TYPICALLY CONSIDERED SUBPANELS AND SHOULD FOLLOW NEC REQUIREMENTS FOR SUBPANELS.



TYPICAL FOUNTAIN "GROUNDING" SCHEMATIC
SCALE: NONE



ELECTRICAL POWER SUPPLY OPTIONS
SCALE: NONE

RECOMMENDED WIRE COLOR CODE

Color code for conductors for general wiring:
1. Color code conductors insulation as follows:

CONDUCTOR	208-240/120	440-480/277	12-24/AC-DC
Phase A	BLACK (BL)	BROWN (BR)	GRAY (GY), BROWN (BR)
Phase B	RED (RD)	ORANGE (OR)	
Phase C	BLUE (BLU)	YELLOW (YL)	
NEUTRAL (COM)	WHITE (WH)	PURPLE (PU), BLUE (BU)	
GROUND	GREEN (GRN)	GREEN (GRN)	GREEN (GRN)

2. For conductors #6 AWG or larger, permanent plastic - colored tape may be used to mark conductor insulation. Tape shall cover not less than 2 inches of conductor insulation within enclosure.

CONDUCTOR	DEVICES	LIGHT FIXTURES	SOLENOIDS	PLC-INPUTS	PLC-OUTPUTS
Phase	RED (RD)	BLACK (BL)	BLACK (BL)	YELLOW (YL)	ORANGE (OR), RED (RD)
NEUTRAL (COM)	WHITE (WH)	WHITE (WH)	WHITE (WH)	WHITE (WH)	WHITE (WH)
GROUND	GREEN (GRN)	GREEN (GRN)	GREEN (GRN)	GREEN (GRN)	GREEN (GRN)

- "BONDING" CONSISTS OF GROUNDING METAL DEVICES.
1. ALL METAL PARTS WITHIN 5 FEET OF THE INSIDE WALLS OF FOUNTAIN AND ALL METAL PARTS OF ASSOCIATED METAL EQUIPMENT MUST BE BONDED TOGETHER PER NEC 680.
 2. ALL BONDING CONDUCTORS SHALL BE OF A SOLID COPPER BONDING JUMPER, INSULATED, COVERED OR BARE, NOT SMALLER THAN 8 AWG, PER NEC.
 3. ALL BONDING SHALL BE CONTINUOUS WITHOUT SPLICES. ALL CONNECTIONS SHALL BE MADE BY EXOTHERMIC WELD OR FITTING APPROVED FOR SUCH USE IN FOUNTAINS AND POOLS.
 4. BONDING WIRES ORIGINATE FROM EITHER A GROUNDING ROD OR FROM THE FOUNTAIN CONTROL PANEL (IF PANEL FEED IS WITH A MINIMUM #8 AWG BOND/GROUND WIRE).
 5. BONDING WIRES ARE TYPICALLY EXTERNAL FROM CONDUITS BUT COULD ORIGINATE FROM THE FOUNTAIN CONTROL PANEL TO A SUBMERSIBLE JUNCTION BOX, THROUGH A CONDUIT, TO AN INTERNAL BONDING LUG, BUT THEN THE REST OF THE BONDING WIRES SHOULD RUN EXTERNALLY BY USE OF JUNCTION BOX EXTERNAL BONDING LUG TO THE POOL REINFORCING STEEL (REBAR) AND TO OTHER POOL METAL DEVICES SUCH AS NICHE LIGHTS.
 6. FOUNTAIN CONTROL PANELS ARE TYPICALLY CONSIDERED SUBPANELS AND SHOULD FOLLOW NEC REQUIREMENTS FOR SUBPANELS.



TYPICAL FOUNTAIN "BONDING" SCHEMATIC
SCALE: NONE

EXCERPT FROM 2011 EDITION OF NEC ARTICLE 680 PERTAINING TO DECORATIVE FOUNTAINS

V. Fountains

680.50 General. The provisions of Part I and Part V of this article shall apply to all permanently installed fountains as defined in 680.2. Fountains that have water common to a pool shall additionally comply with the requirements in Part II of this article. Part V does not cover self-contained, portable fountains. Portable fountains shall comply with Parts II and III of Article 422.

680.51 Luminaires, Submersible Pumps, and Other Submersible Equipment.

(A) Ground-Fault Circuit Interrupter. Luminaires, submersible pumps, and other submersible equipment, unless listed for operation at low voltage contact limit or less and supplied by a transformer or power supply that complies with 680.23(A)(2), shall be protected by a ground-fault circuit interrupter.

(B) Operating Voltage. No luminaires shall be installed for operation on supply circuits over 150 volts between conductors. Submersible pumps and other submersible equipment shall operate at 300 volts or less between conductors.

(C) Luminaire Lenses. Luminaires shall be installed with the top of the luminaire lens below the normal water level of the fountain unless listed for above-water locations. A luminaire facing upward shall comply with either (1) or (2):

- (1) Have the lens adequately guarded to prevent contact by any person
- (2) Be listed for use without a guard

(D) Overheating Protection. Electrical equipment that depends on submersion for safe operation shall be protected against overheating by a low-water cutoff or other approved means when not submerged.

(E) Wiring. Equipment shall be equipped with provisions for threaded conduit entries or be provided with a suitable flexible cord. The maximum length of each exposed cord in the fountain shall be limited to 3.0 m (10 ft). Cords extending beyond the fountain perimeter shall be enclosed in approved wiring enclosures. Metal parts of equipment in contact with water shall be of brass or other approved corrosion-resistant metal.

(F) Servicing. All equipment shall be removable from the water for relamping or normal maintenance. Luminaires shall not be permanently embedded into the fountain structure such that the water level must be reduced or the fountain drained for relamping, maintenance, or inspection.

(G) Stability. Equipment shall be inherently stable or be securely fastened in place.

680.52 Junction Boxes and Other Enclosures.

(A) General. Junction boxes and other enclosures used for other than underwater installation shall comply with 680.24.

(B) Underwater Junction Boxes and Other Underwater Enclosures. Junction boxes and other underwater enclosures shall meet the requirements of 680.52(B)(1) and (B)(2).

(1) Construction.

- (a) Underwater enclosures shall be equipped with provisions for threaded conduit entries or compression glands or seals for cord entry.
- (b) Underwater enclosures shall be submersible and made of copper, brass, or other approved corrosion-resistant material.

(2) Installation. Underwater enclosure installations shall comply with (a) and (b).

- (a) Underwater enclosures shall be filled with an approved potting compound to prevent the entry of moisture.
- (b) Underwater enclosures shall be firmly attached to the supports or directly to the fountain surface and bonded as required. Where the junction box is supported only by conduits in accordance with 314.23(C) and (F), the conduits shall be of copper, brass, stainless steel, or other approved corrosion-resistant metal. Where the box is fed by nonmetallic conduit, it shall have additional supports and fasteners of copper, brass, or other approved corrosion-resistant material.

V. Fountains (Cont.)

680.53 Bonding. All metal piping systems associated with the fountain shall be bonded to the equipment grounding conductor of the branch circuit supplying the fountain.
Informational Note: See 250.122 for sizing of these conductors.

680.54 Grounding. The following equipment shall be grounded:

- (1) Other than listed low-voltage luminaires not requiring grounding, all electrical equipment located within the fountain or within 1.5 m (5 ft) of the inside wall of the fountain
- (2) All electrical equipment associated with the recirculating system of the fountain
- (3) Panelboards that are not part of the service equipment and that supply any electrical equipment associated with the fountain

680.55 Methods of Grounding.

(A) Applied Provisions. The provisions of 680.21(A), 680.23(B)(3), 680.23(F)(1) and (F)(2), 680.24(F), and 680.25 shall apply.

(B) Supplied by a Flexible Cord. Electrical equipment that is supplied by a flexible cord shall have all exposed non-current-carrying metal parts grounded by an insulated copper equipment grounding conductor that is an integral part of this cord. The equipment grounding conductor shall be connected to an equipment grounding terminal in the supply junction box, transformer enclosure, power supply enclosure, or other enclosure.

680.56 Cord-and-Plug-Connected Equipment.

(A) Ground-Fault Circuit Interrupter. All electrical equipment, including power-supply cords, shall be protected by ground-fault circuit interrupters.

(B) Cord Type. Flexible cord immersed in or exposed to water shall be of a type for extra-hard usage, as designated in Table 400.4, and shall be a listed type with a "W" suffix.

(C) Sealing. The end of the flexible cord jacket and the flexible cord conductor termination within equipment shall be covered with, or encapsulated in, a suitable potting compound to prevent the entry of water into the equipment through the cord or its conductors. In addition, the ground connection within equipment shall be similarly treated to protect such connections from the deteriorating effect of water that may enter into the equipment.

(D) Terminations. Connections with flexible cord shall be permanent, except that grounding-type attachment plugs and receptacles shall be permitted to facilitate removal or disconnection for maintenance, repair, or storage of fixed or stationary equipment not located in any water-containing part of a fountain.

NOTE: For a complete copy of 2011 edition of NEC Article 680 (680.1 through 680.74) please contact:
NFPA
1 Batterymarch Park
Quincy, MA 02169-7471

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TYPICAL ELECTRICAL
DETAILS & ARTICLE
680 NEC
REQUIREMENTS

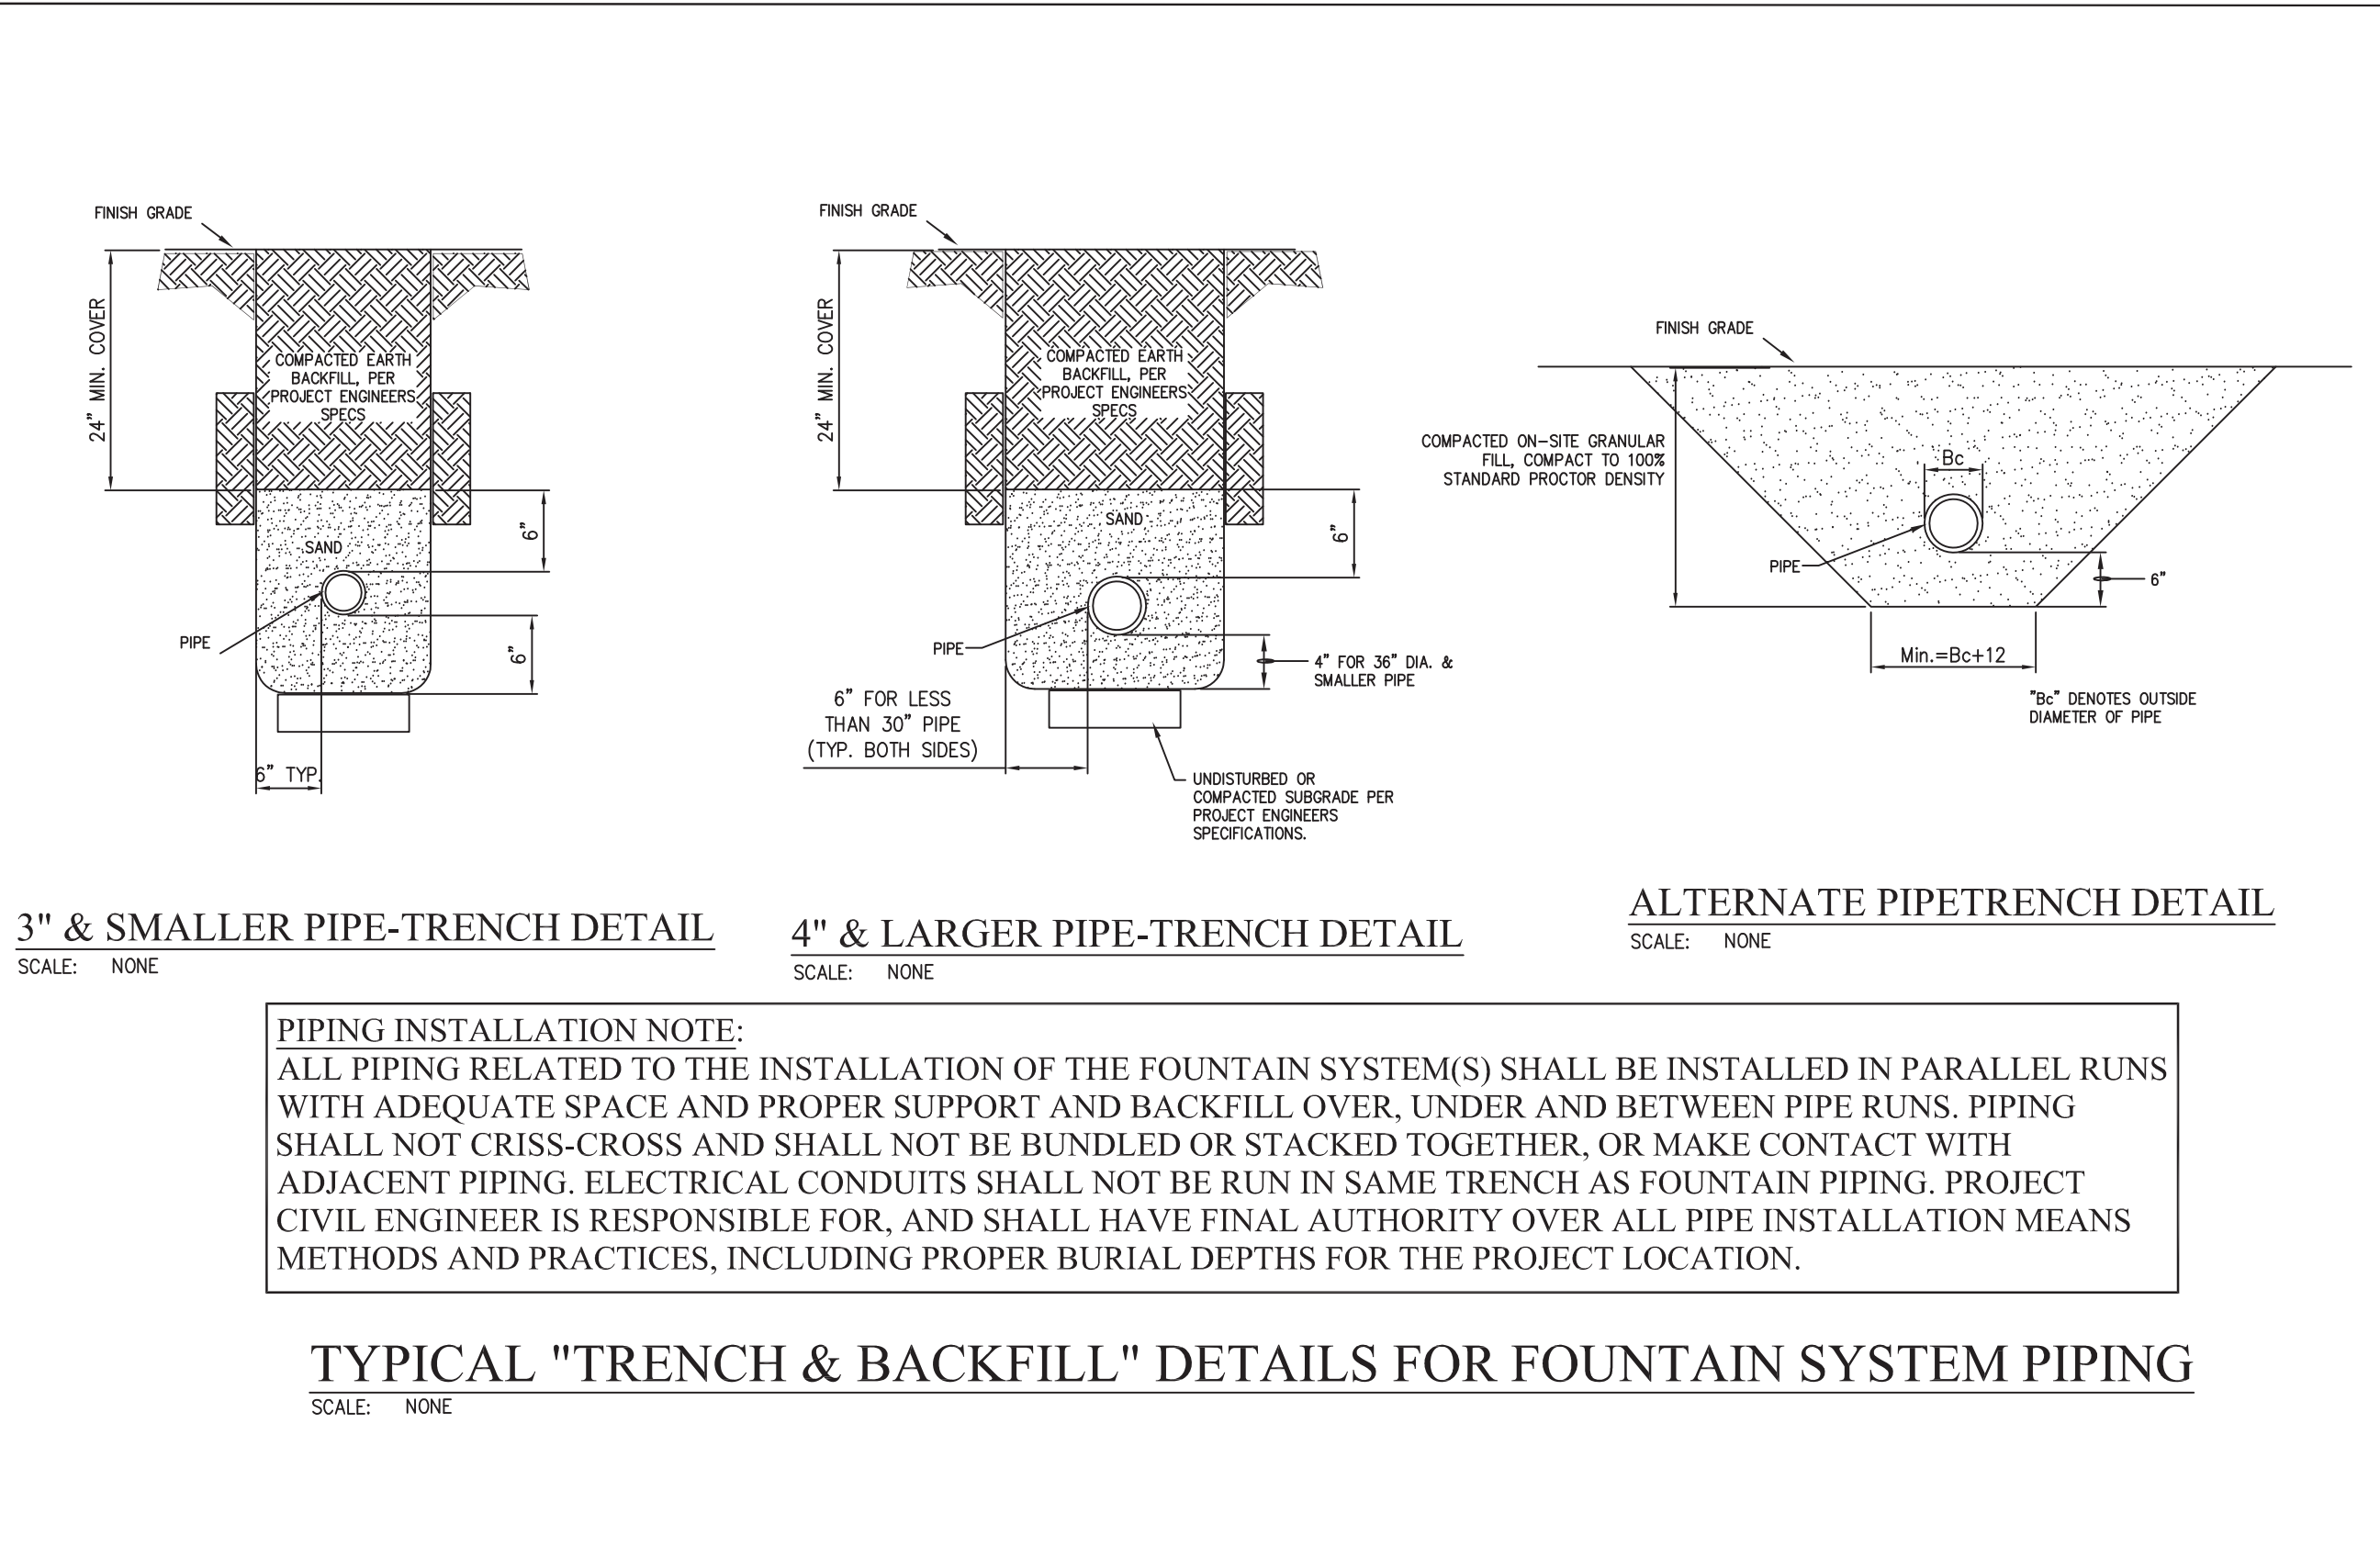
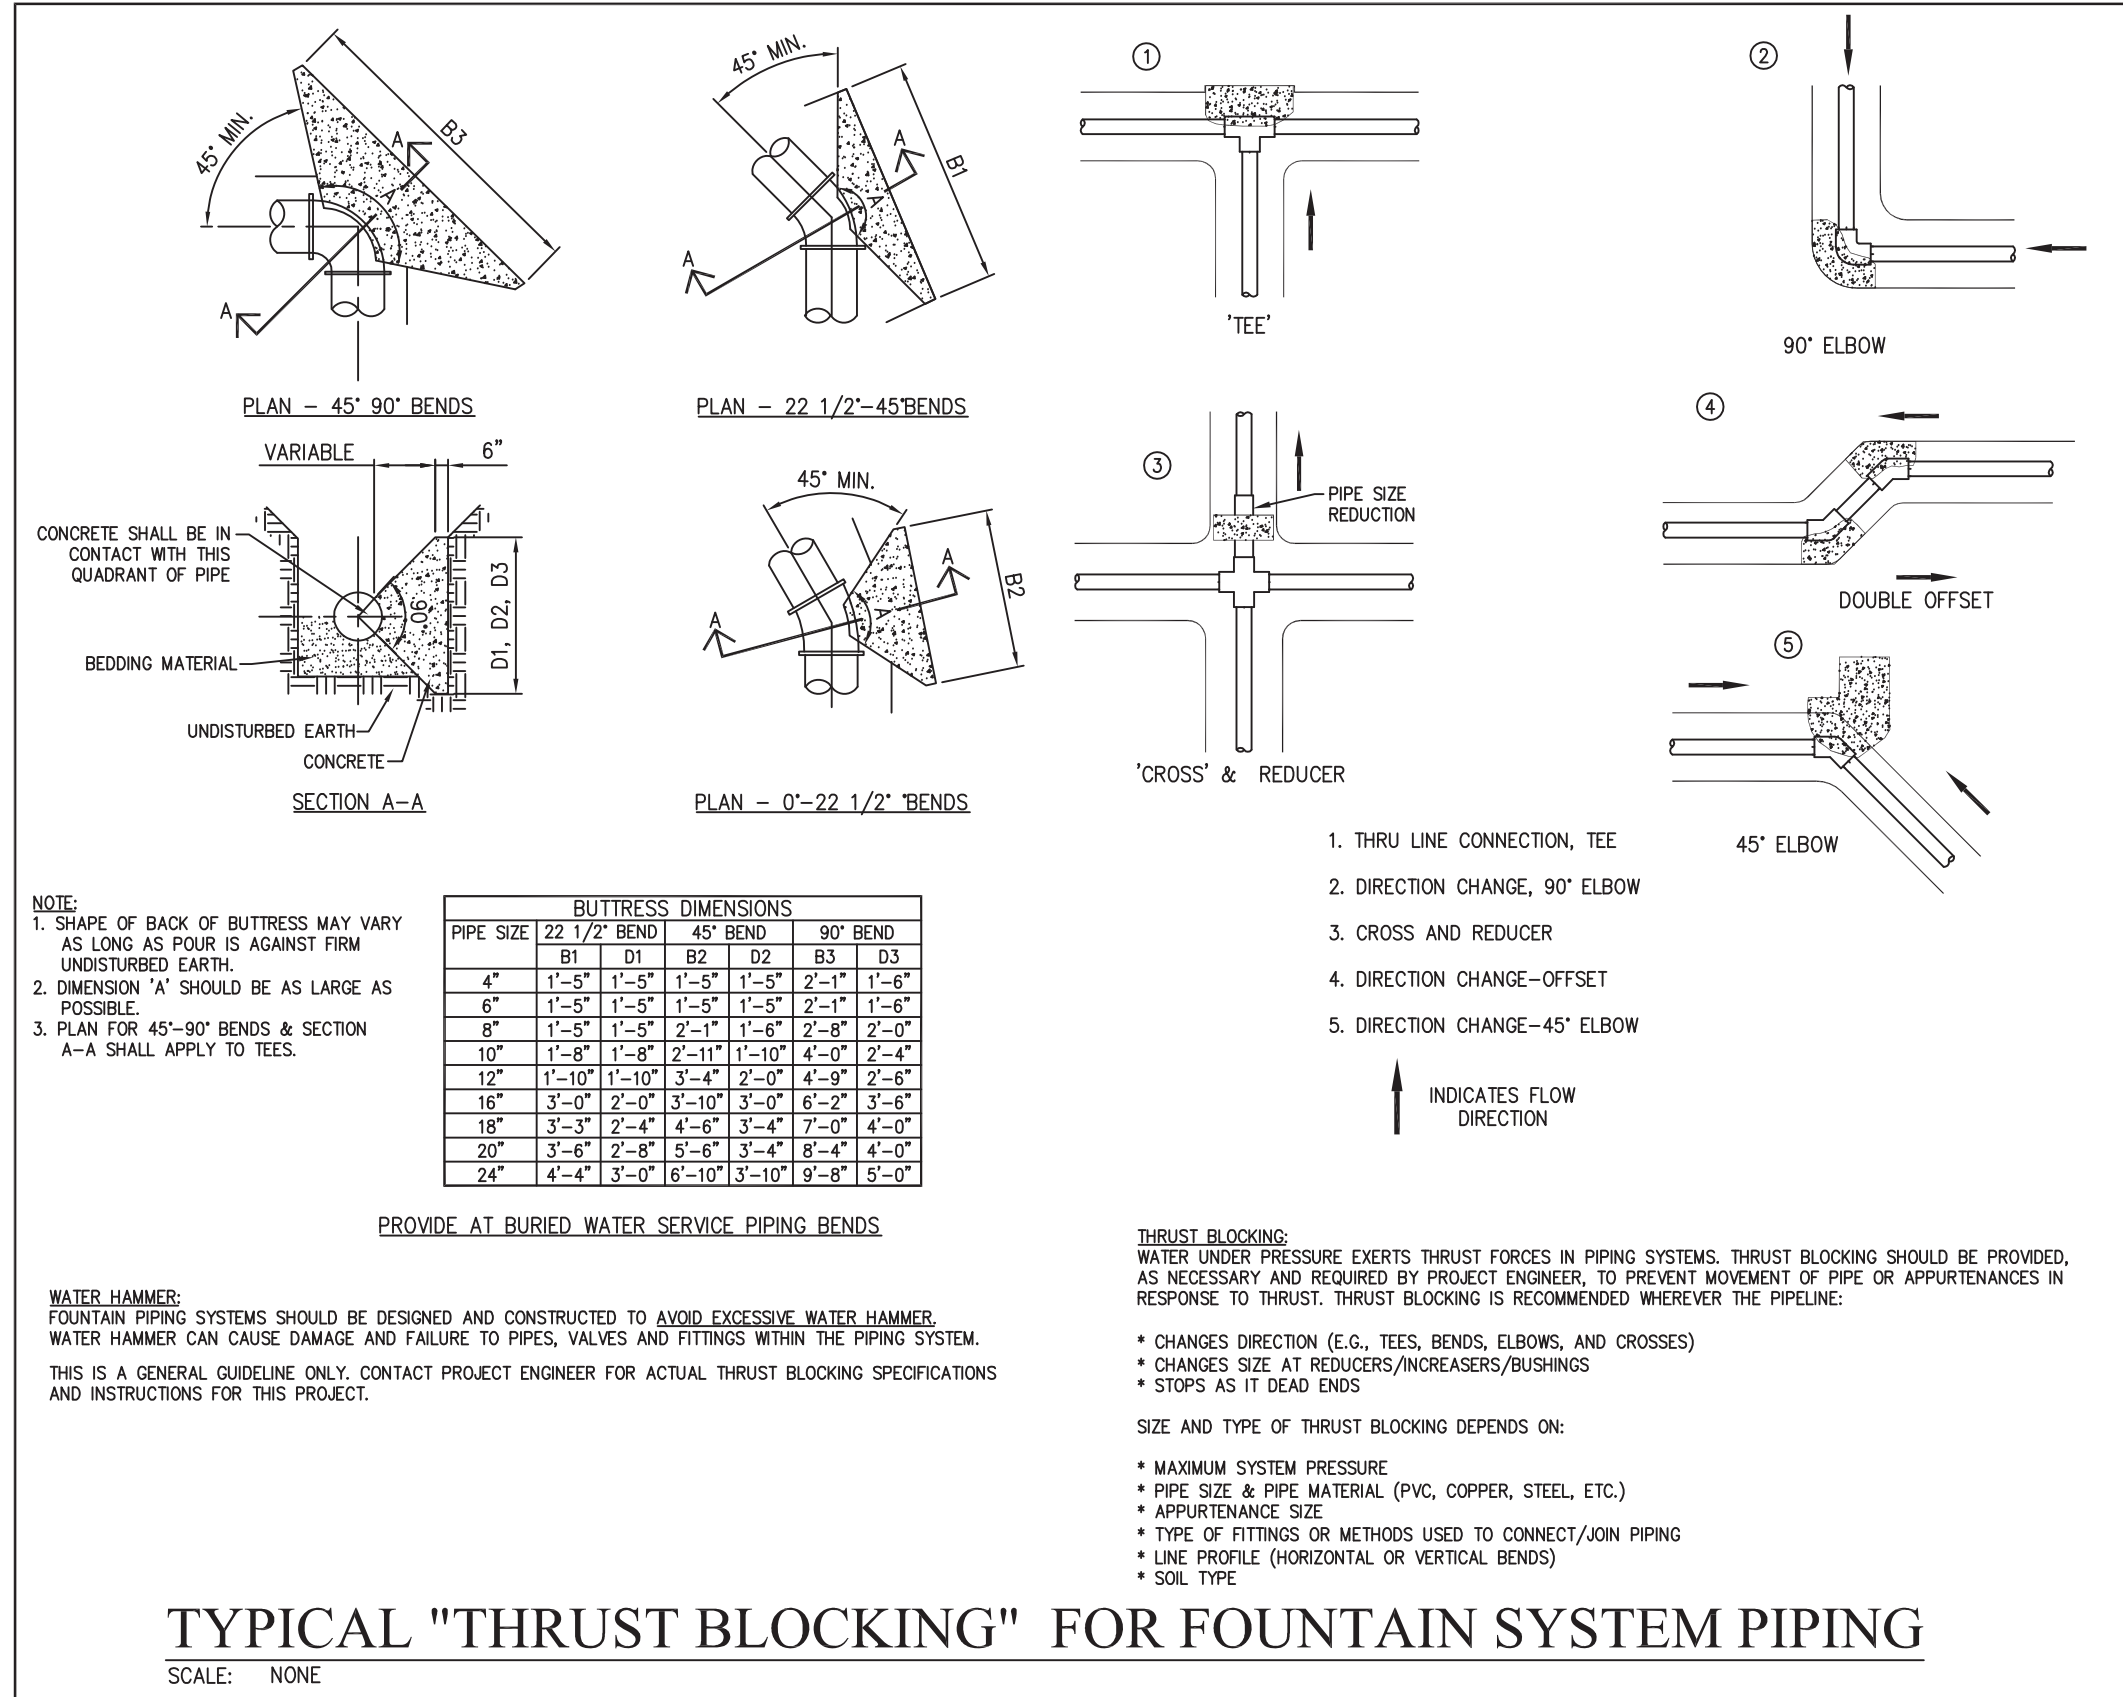


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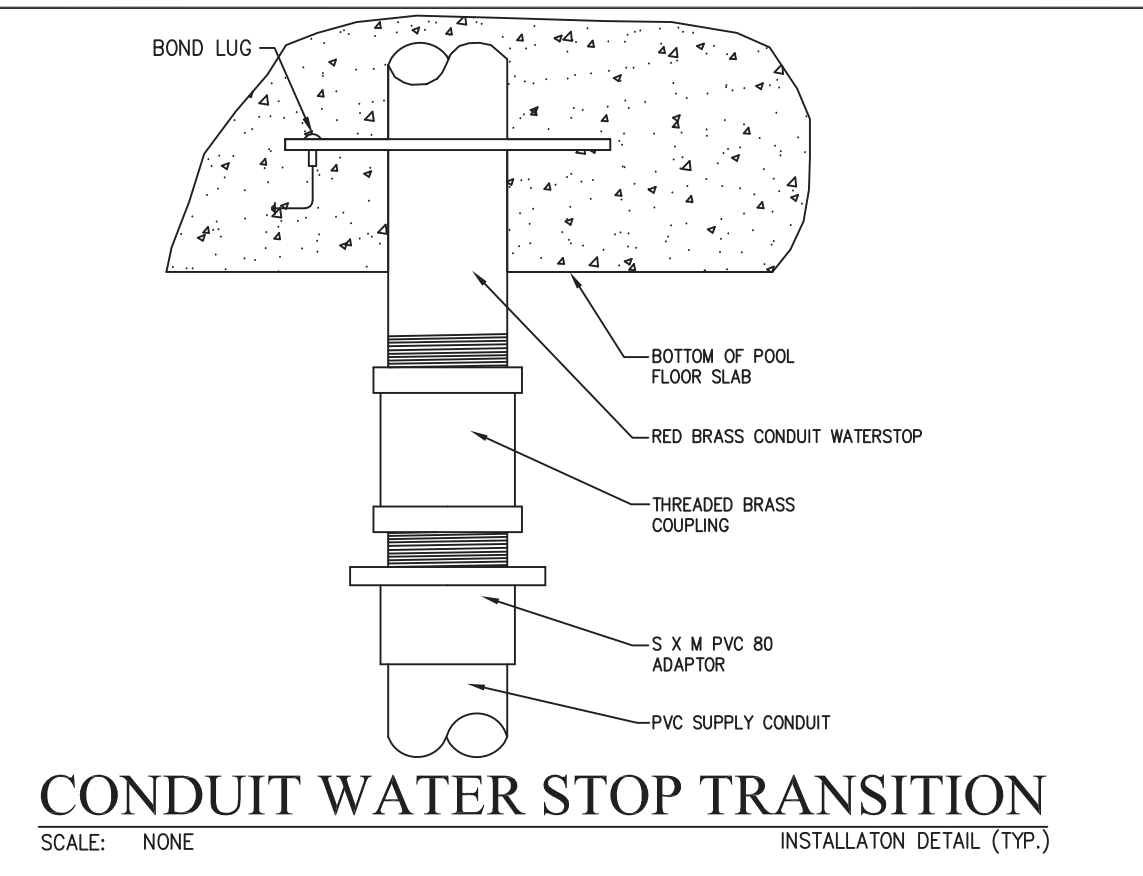
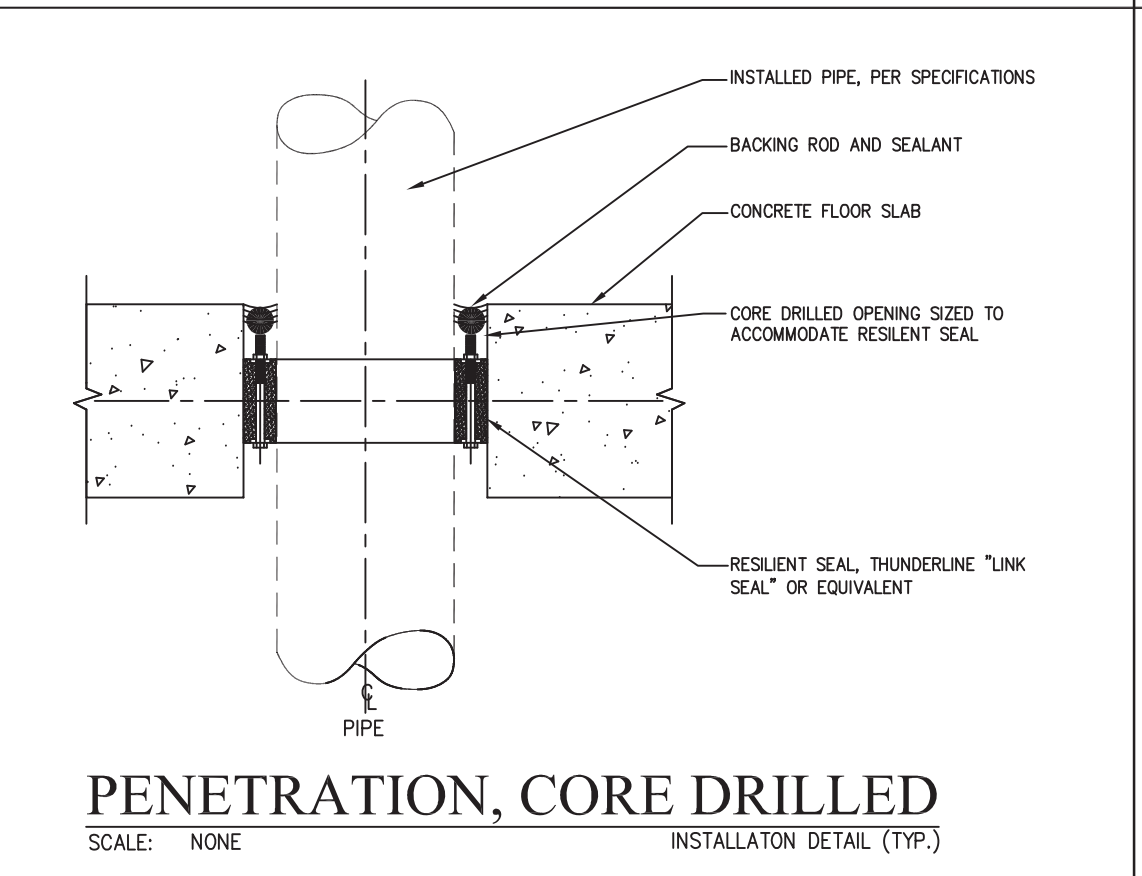
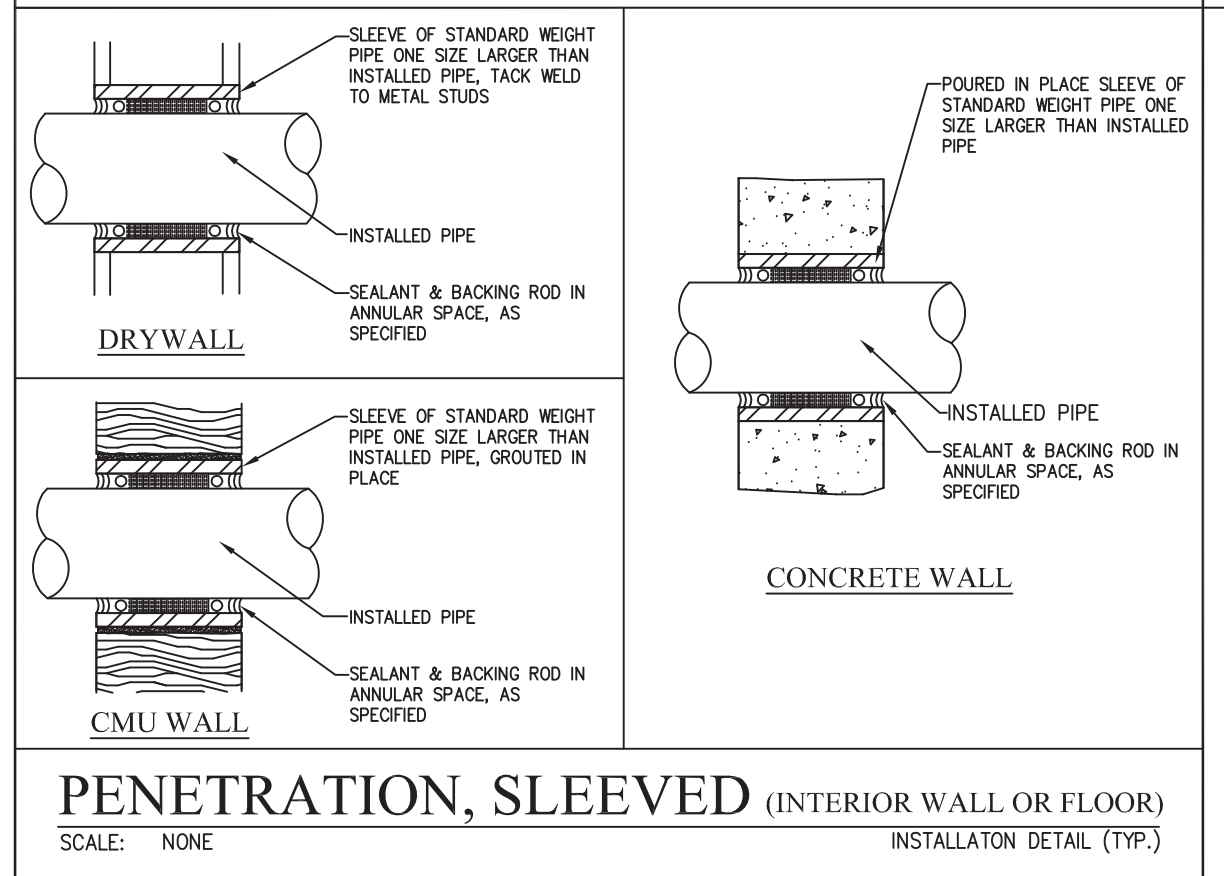
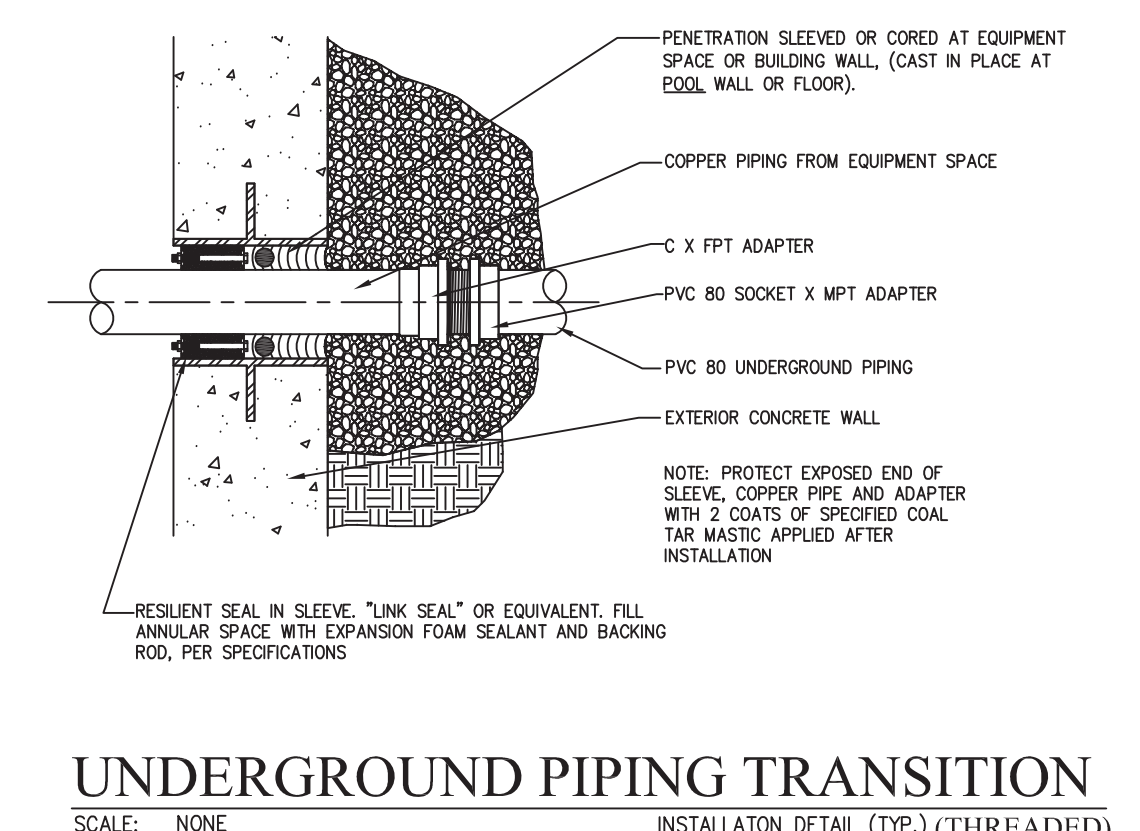
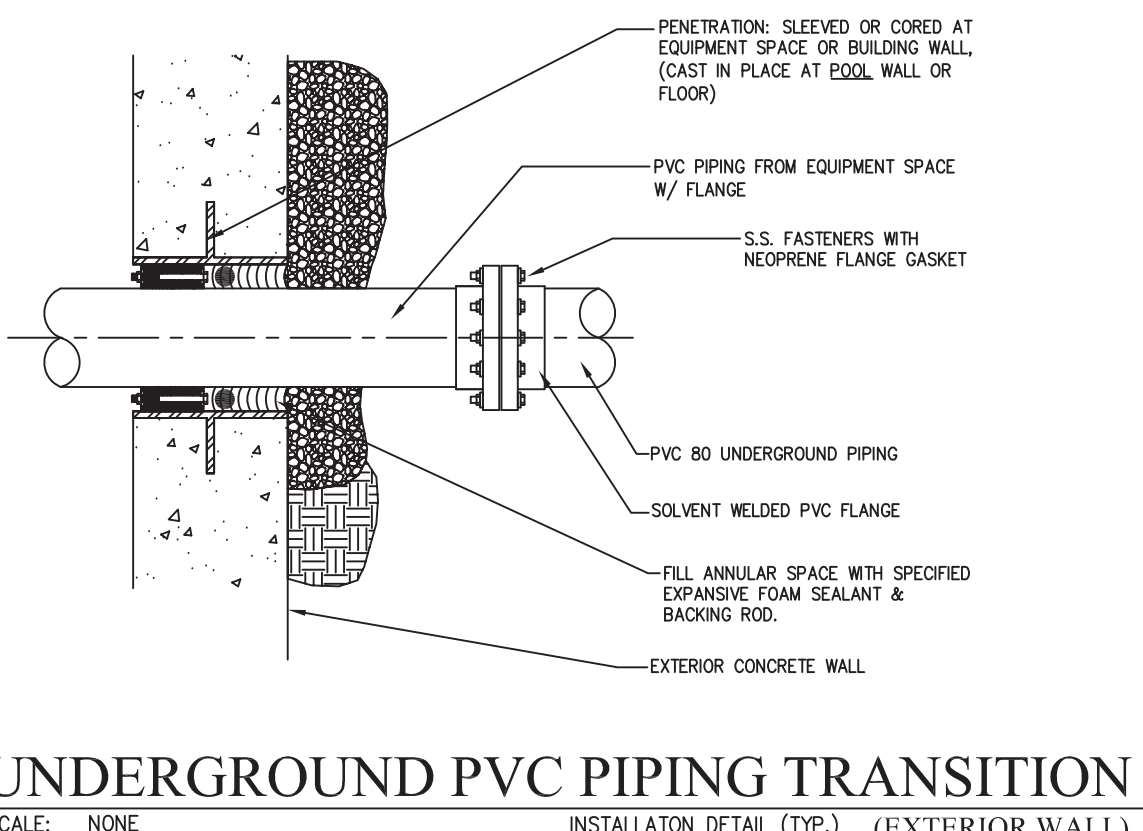
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PIPE SEAL/SLEEVE SIZE TABLE
SCALE: NONE

PIPE SIZE (NOMINAL)	OUTSIDE DIAMETER (PIPE O.D.)	CAST OR DRILLED CONCRETE HOLE INSIDE DIA. (I.D.) IN.	LINK SEAL SIZE NO.	NO. OF LINKS PER SEAL
1/2"	0.840	2.0	LS-200	4
3/4"	1.050	3.0	LS-315	4
1"	1.315	3.0	LS-300	4
1 1/4"	1.660	3.0	LS-275	8
1 1/2"	1.900	4.0	LS-315	6
2"	2.375	4.0	LS-300	6
2 1/2"	2.875	4.0	LS-200	9
3"	3.506	5.0	LS-300	8
3 1/2"	4.00	6.0	LS-315	10
4"	4.50	6.0	LS-300	10
5"	5.563	8.0	LS-340	13
6"	6.625	10.0	LS-475	10
8"	8.625	12.0	LS-475	12
10"	10.75	14.0	LS-475	14
12"	12.75	16.0	LS-475	17

"LINK-SEAL" AND "CENTURY-LINE" IS A PRODUCT OF THUNDERLINE CORPORATION, HOUSTON, TX.



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TYPICAL PIPING AND PENETRATION DETAILS





SHEET NUMBER **L30**

Y:\2015-Jobs\Walterboro (Wood + Partners, Inc) Design\Drawings\Walterboro\WoodPartners\Design.dwg 2/17/2016 6:13:41 PM CHRIS

1211 Miccosukee Road Tallahassee, FL 32308
850.391.0380 • Fax 850.386.1010 • www.woodandpartners.com

FED. RD. DIV. NO.	STATE	COUNTY	PROJECT ID	PROJECT NO.	ROUTE NO.	SHEET NO.	TOTAL SHEETS
3	S.C.	COLLETON	0041932	31588.00	SC 63	PM01	

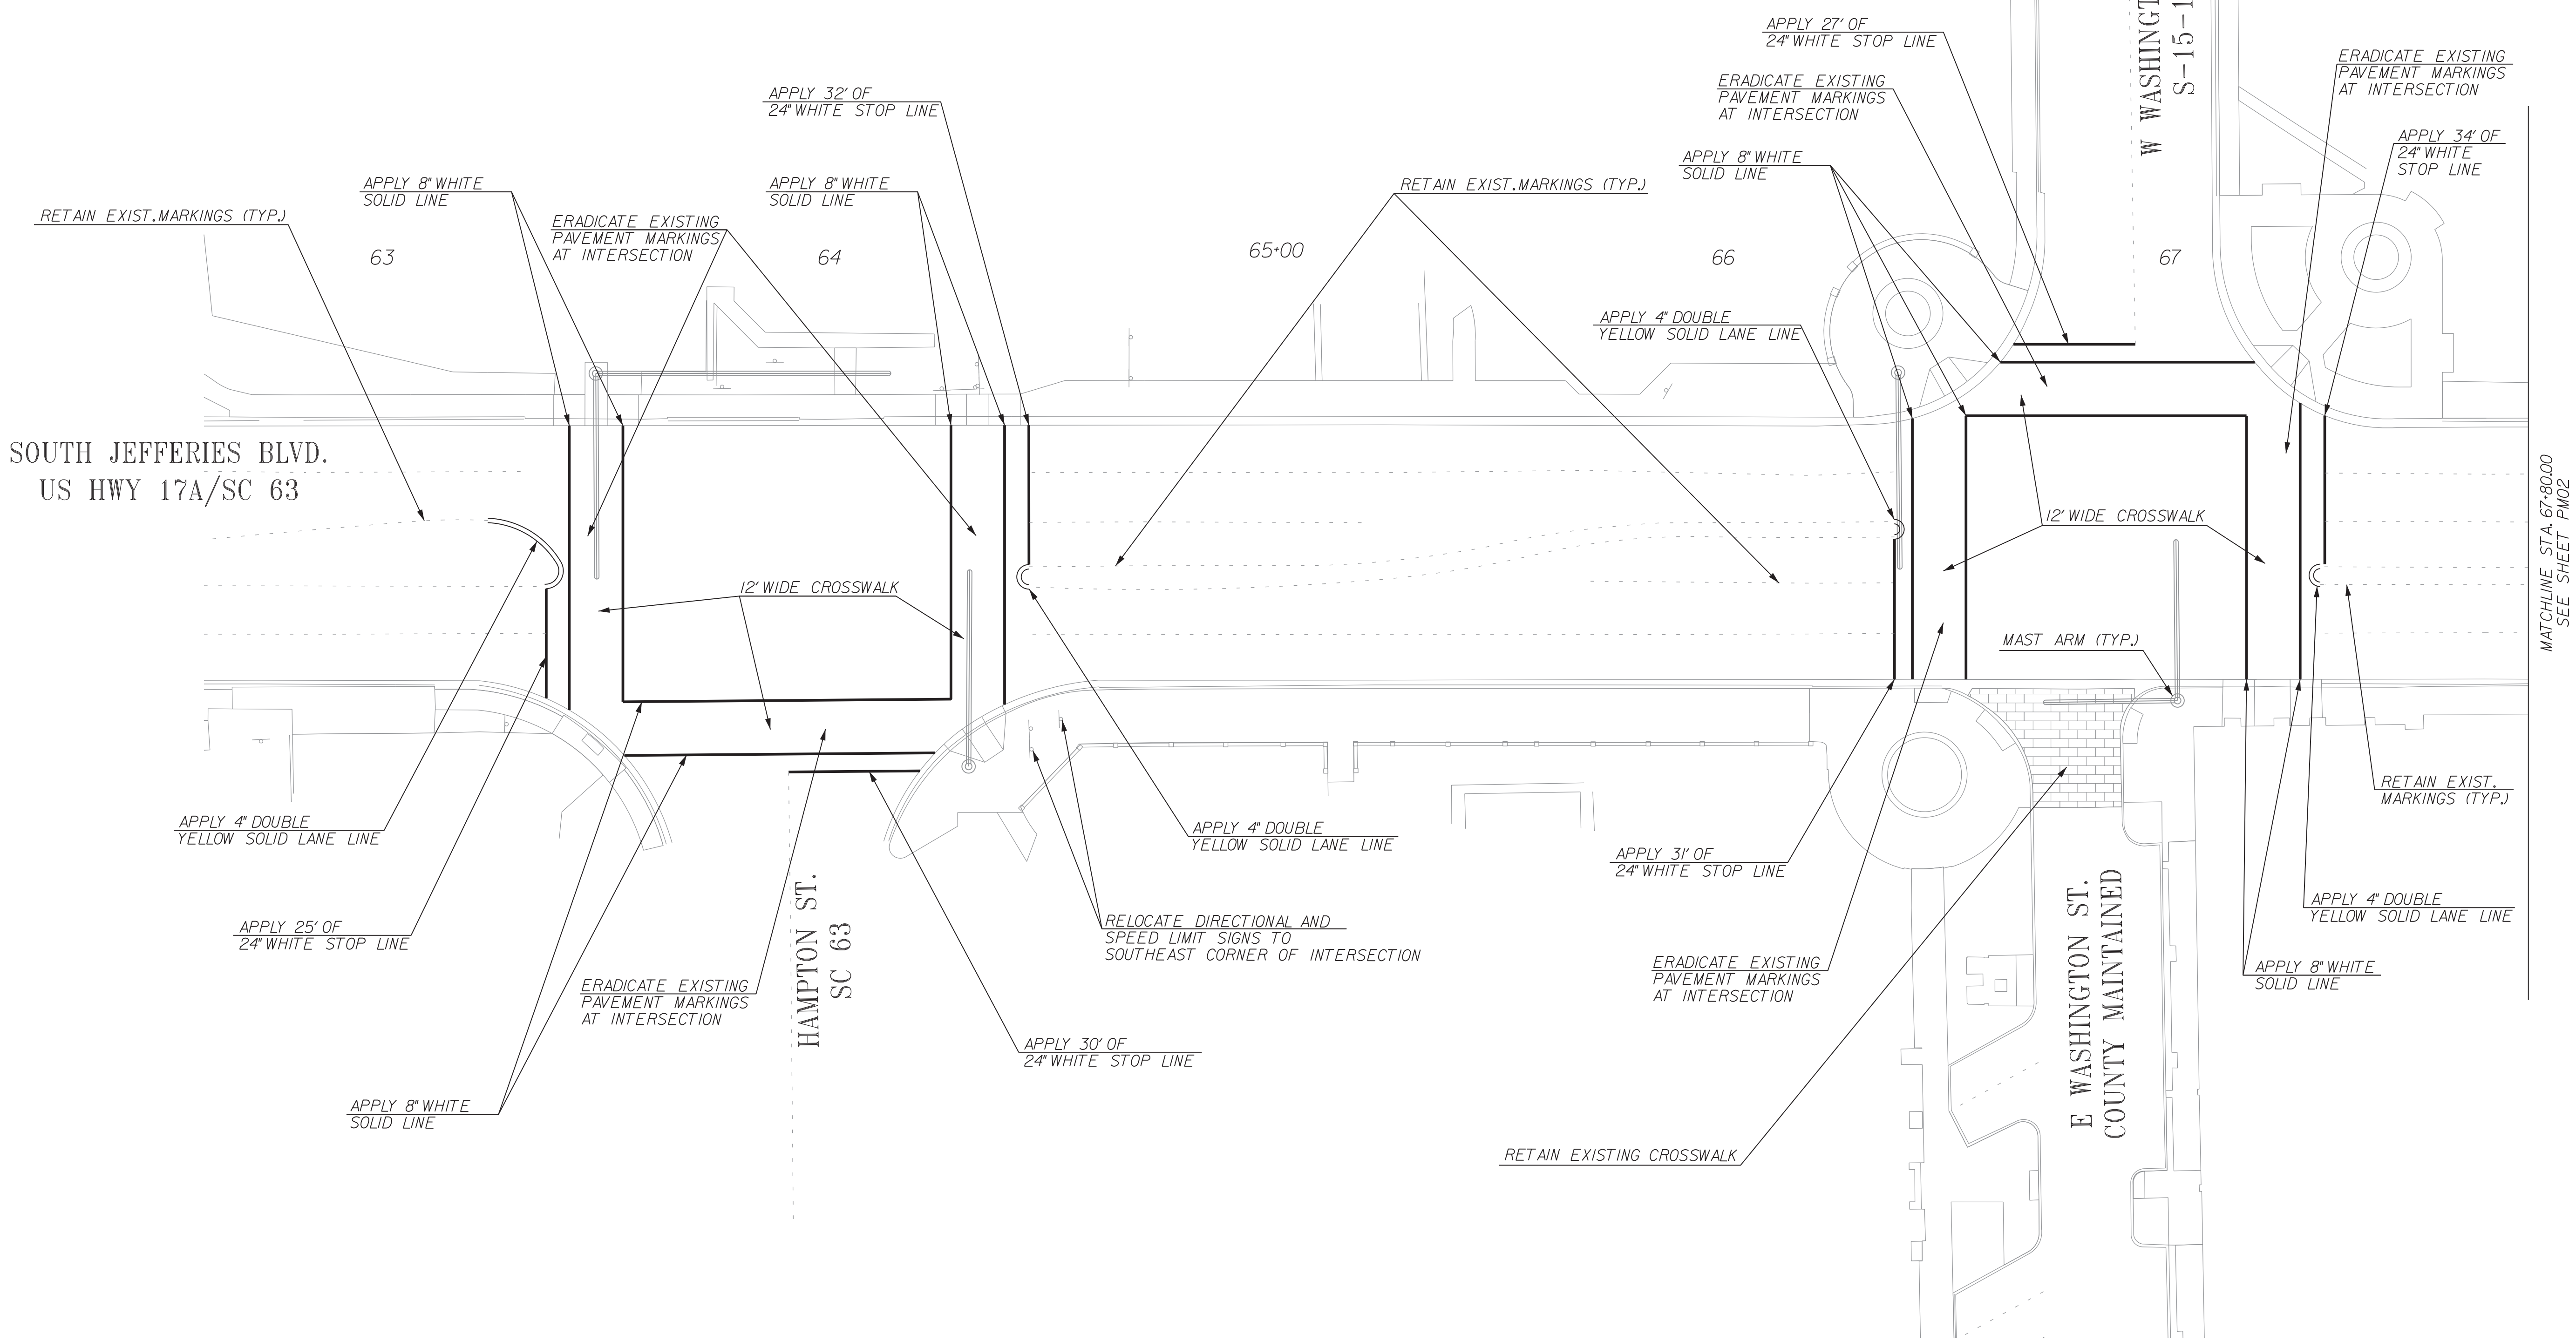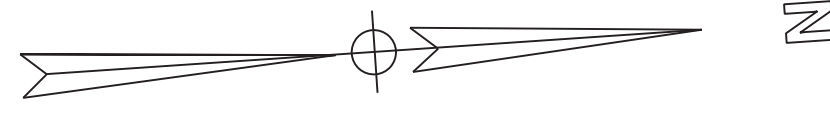SOUTH JEFFERIES BLVD



MATCHLINE STA. 67+80.00
SEE SHEET PM02

NOTES:
1. RETAIN EXISTING SIGNS UNLESS OTHERWISE SPECIFIED ON PLANS.

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SINCE 1954

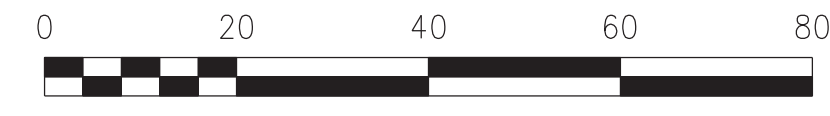
3229 W. MONTAGUE AVENUE
COLUMBIA, SC 29405
(803) 733-2900

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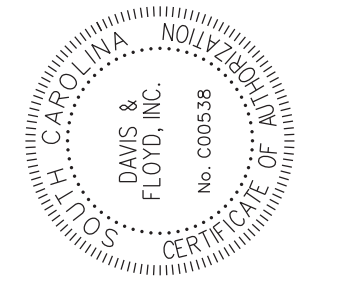
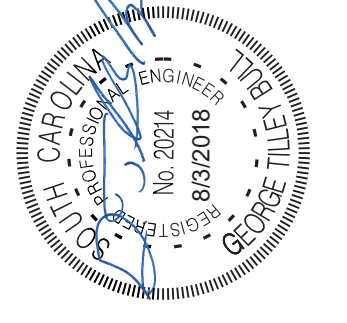
612 S. Capeland Street ■ Tallahassee, FL 32304
850.391.0360 ■ Fax 850.396.1010 ■ www.woodandpartners.com



SCALE: 1" = 20'



PREPARED FOR:
**I-95 BUSINESS LOOP
PHASE 1B
PAVEMENT MARKINGS SHEET**
Walterboro, South Carolina



DGN: LEK
R/W: GBT
CHK: GBT

REVISION	DATE	BY
#		

SHEET NUMBER
PM01

FILE NAME: \CHS-FSD\Auto\Jobs\Even\31588-00\CV_dgn\pavmark-Phase 1B (1B1)-Feeder\3158800-1B-PM01.dgn
11:40:27 AM
PLOTTED: 8/3/2018

SIGNAL HEAD DISPLAY CHART

HEAD NUMBER	2	4	4,5con	5,6F	6	4P	6P
LENS	(R) (Y) (G)	(R) (Y) (G)	(R) (Y) (G)	(R) (Y) (G)	(R) (Y) (G)	(R) (Y) (G)	(R) (Y) (G)
PHASE	2	4	4,5	5,6	6	4P	6P
SIZE	12"	12"	12"	12"	12"	16"	16"
QUANTITY	2	1	1	1	2	2	2

EQUIPMENT INFORMATION


CONTROLLER	CONTRACTOR SUPPLIED 2070L
CABINET	CONTRACTOR SUPPLIED 332A
CABINET MOUNT	CONCRETE BASE
PHASES USED	2,4,5,6,4P,6P
OVERLAPS	OLA=____, OLB=____, OLC=05+06 (FYA), OLD=____

PEDESTRIAN SIGNALS: EXT. PROP. W/ACT. & SIGN EXT. PROP.

VEHICLE SIGNALS: EXT. PROP.

METAL POLES AS NECESSARY: EXT. PROP.
WOOD POLES AS NECESSARY: EXT. PROP.

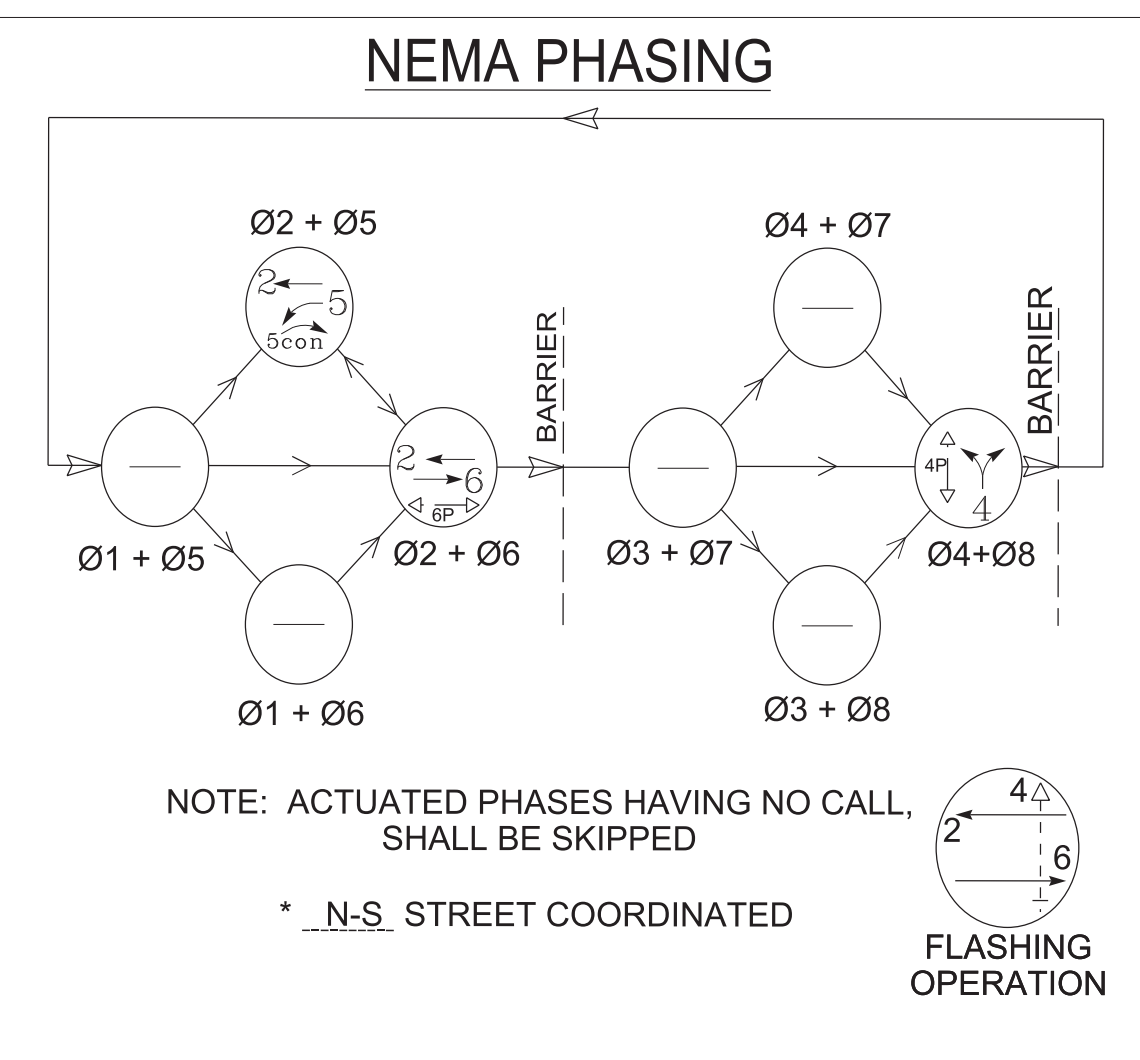- NOTES:
- ALL PEDESTRIAN SIGNAL HEADS SHALL BE 'COUNTDOWN' HEADS.
 - INSTALL BACKPLATES WITH RETROREFLECTIVE BORDERS ON ALL VEHICLE SIGNAL HEADS.
 - PEDESTRIAN PUSH BUTTON LIGHTS SHALL BE LATCHING.
 - PUSH BUTTONS SHALL BE WITHIN 18" OF SIDEWALK.




- NOTES:
- THE LOCATION OF CONDUIT, JUNCTION BOXES, CABINETS, AND TRAFFIC SIGNAL POLES SHOWN ON THE PLAN ARE APPROXIMATE. THE CONTRACTOR SHALL CONTACT 'BI' AND ANY OTHER UTILITY COMPANIES NECESSARY TO VERIFY THE LOCATION OF ALL UNDERGROUND UTILITIES BEFORE DIGGING.
 - ALL EQUIPMENT, MATERIALS, AND WORKMANSHIP SHALL MEET THE STANDARDS OUTLINED IN THE MUTCD (LATEST EDITION), SCOT STANDARD DRAWINGS, AND THE SCOT TRAFFIC SIGNAL SPECIFICATIONS. ALL TRAFFIC SIGNAL EQUIPMENT AND MATERIALS REMOVED DURING THIS PROJECT SHALL BE RETURNED TO THE SCOT OR DISPOSED OF AS DIRECTED BY THE ENGINEER.
 - THE CONTRACTOR IS REQUIRED TO MAINTAIN THE TRAFFIC SIGNAL OPERATION AT ALL TIMES DURING CONSTRUCTION OF THIS PROJECT. ALL COSTS FOR TEMPORARY SIGNAL EQUIPMENT AND TEMPORARY ADJUSTMENT OF THE TRAFFIC SIGNAL EQUIPMENT SHALL BE INCLUDED IN THE LINE ITEM BID FOR 'TEMPORARY ADJUSTMENT OF TRAFFIC SIGNAL EQUIPMENT'.
 - DISTRICT 6 SIGNAL SHOP MUST BE CONTACTED PRIOR TO THE START OF ANY WORK.
 - THE CONTRACTOR SHALL OBTAIN REQUIRED SOIL INFORMATION AND DESIGN THE POLE FOUNDATIONS AS PART OF THE UNIT BID PRICE FOR THE MAST ARMS. THE CONTRACTOR SHALL VERIFY THAT THE SIGNAL POLE FOUNDATION WILL NOT CONFLICT WITH EXISTING UNDERGROUND UTILITIES PRIOR TO ORDERING TRAFFIC SIGNAL MAST ARMS. ANY DEVIATIONS TO THE SIGNAL POLE FOUNDATION LOCATION MAY REQUIRE MODIFICATIONS TO THE MAST ARM LENGTHS.
 - POWER FOR LUMINAIRES SHALL BE PROVIDED ON A SEPARATE CIRCUIT AND METER FROM THE TRAFFIC SIGNAL.

SIGNAL DISPLAY SEQUENCE CHART

PHASE ON (A)	NON-CONFLICTING PHASE (B)	CONFLICTING PHASE *
1	5, 6, 6P	2,3,4,7,8,2P,4P,8P
2	5, 6, 2P, 6P	1,3,4,7,8,4P,8P
3	7, 8, 6P	1,2,4,5,6,2P,4P,8P
4	7, 8, 4P, 6P	1,2,3,5,6,2P,8P
5	1,2,2P	3,4,6,7,8,4P,8P
6	1,2,2P,6P	3,4,5,7,8,4P,8P
7	3,4,4P	1,2,5,6,8,2P,6P
8	3,4,4P,8P	1,2,5,6,7,2P,6P

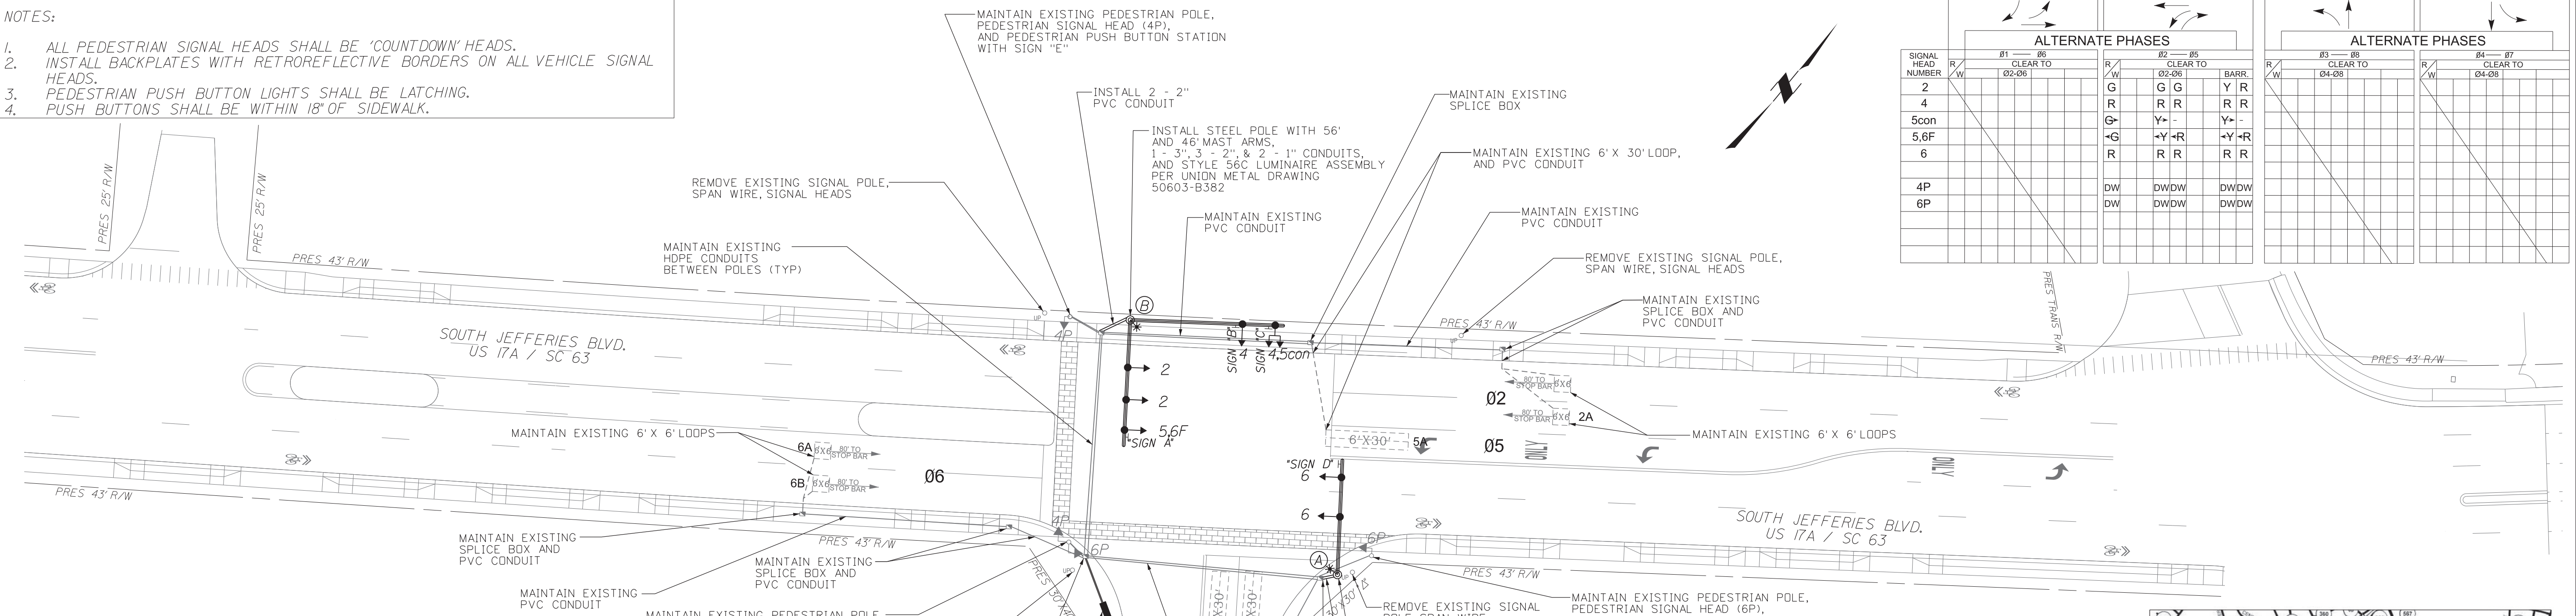* WHEN CALLED, DISPLAY SOLID 'WALKING' PERSON AND TIMES OUT WALK TIMING; THEN DISPLAYS FLASHING 'UPRAISED HAND' AND TIMES WALK CLEARANCE (DON'T WALK TIMING); THEN DISPLAYS A SOLID 'UPRAISED HAND'.



SIGNAL TIMINGS


	PHASE							
	1	2	3	4	5	6	7	8
WALK	---	---	---	7.0	---	7.0	---	---
DON'T WALK	---	---	---	20	---	32	---	---
MIN INITIAL	---	15	---	8.0	8.0	15	---	---
MAX INITIAL	---	---	---	---	---	---	---	---
ADD/VEH	---	---	---	---	---	---	---	---
VEH EXT	---	3.0	---	3.5	3.0	3.0	---	---
TIM BFR REDUC	---	---	---	---	---	---	---	---
TIME TO REDUC	---	---	---	---	---	---	---	---
MIN GAP	---	3.0	---	3.5	3.0	3.0	---	---
MAX LIMIT	---	60	---	25	15	60	---	---
MAXIMUM 2	---	---	---	---	---	---	---	---
YELLOW	---	4.0	---	4.0	4.0	4.0	---	---
RED CLEAR	---	2.9	---	3.2	2.9	2.9	---	---

POLE CHART

POLE	NORTHING	EASTING	MAST ARM SPAN LENGTH
A	387665.7536	2101375.9137	42'
B	387689.2672	2101259.1473	56' / 46'

LOOP DETECTOR INSTALLATION CHART

PHASE/DETECTOR	WIRE TO	LOCK	NON-LOCK	PULSE	OPERATION	SPECIAL FEATURES	LOOP DESIGN
LOOP LTR#	AMP NO.	CHAN NO.	PHASE(S)	X	X	TIME OF DAY-TOD, SWITCHING, etc.	SIZE X NO. OF TURNS DIST. FROM
2A	2	X	X	X			6'x6' 4 80'
2B	2	X	X	X			6'x6' 4 80'
4A	4	X	X	X		QUADRUPOLE	6'x30' 2-4-2 -2'
4B	4	X	X	X	15	QUADRUPOLE	6'x30' 2-4-2 -2'
5A	5	X	X	X		QUADRUPOLE	6'x30' 2-4-2 -2'
6A	6	X	X	X			6'x6' 4 80'
6B	6	X	X	X			6'x6' 4 80'

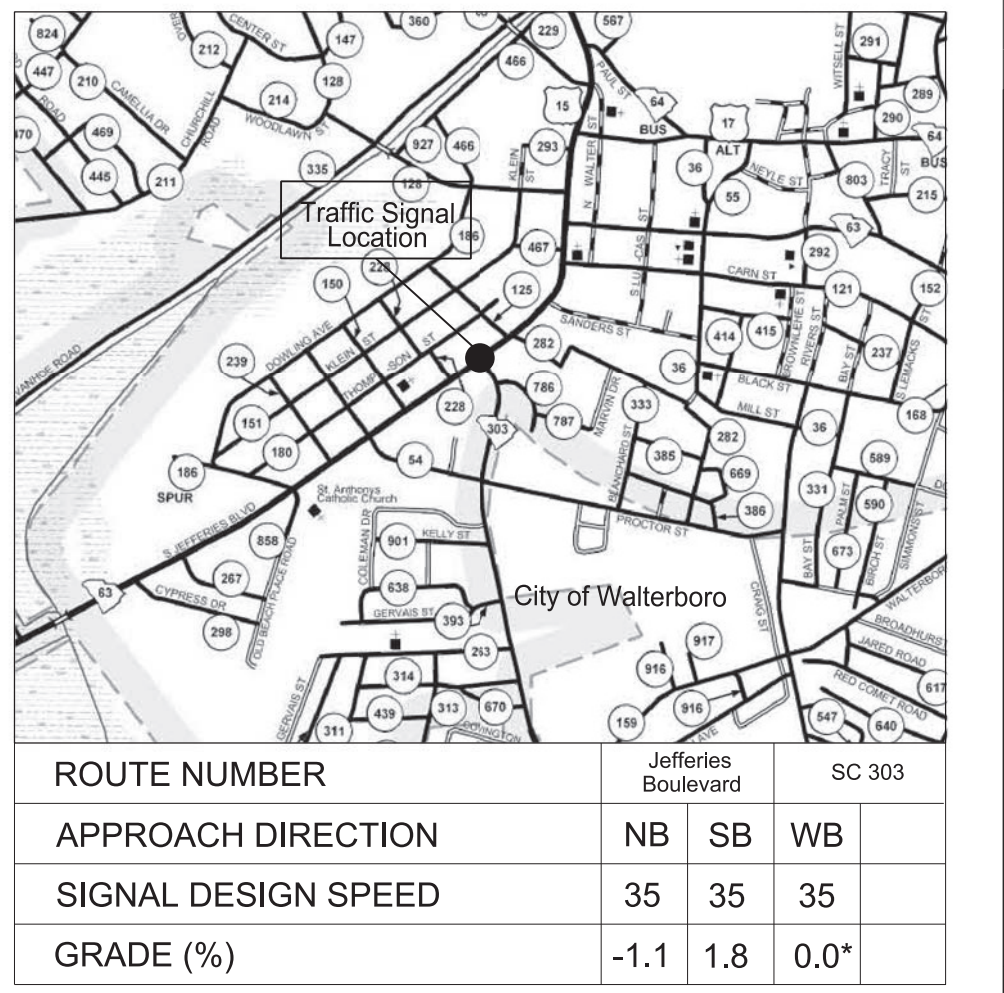

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SINCE 1954

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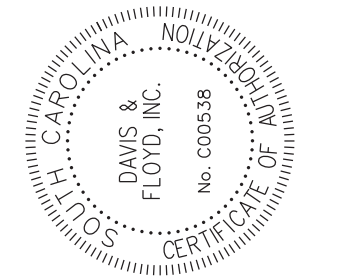
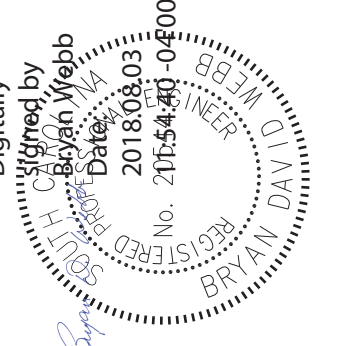
Wood+Partners Inc. WiPi
Landscape Architects
Land Planners



SCALE: 1" = 30'



I-95 BUSINESS LOOP PHASE 1B
SOUTH JEFFERIES BLVD. & GREEN POND HWY
Walterboro, South Carolina



DGN: LMT
R/W:
CHK: BDW

DATE	BY	REVISION

SHEET NUMBER
TS1

FILE NAME: \CHS-F\SD\Drawings\Even\31588-000\CV (1B)\Federal\3158800-1B\TS1\Jeffries-Greenpond_Phase1B.dgn
PLOTTED: 8/3/2018 10:46:51 AM

FED. RD. DIV. NO.	STATE	COUNTY	PROJECT ID	PROJECT NO.	ROUTE NO.	SHEET NO.	TOTAL SHEETS
3	S.C.	COLLETON	0041932	31588.00	SC 63	TS3	

SIGNAL HEAD DISPLAY CHART

HEAD #	2	4	4,5con	5,6F	6	4P	6P
DISPLAY							
PHASE	2	4	4,5	5,OLC	6	4P	6P
SIZE	12"	12"	12"	12"	12"	16"	16"
QUANTITY	2	1	1	1	2	4	2

EQUIPMENT INFORMATION


CONTROLLER	CONTRACTOR SUPPLIED 2070L
CABINET	CONTRACTOR SUPPLIED 332
CABINET MOUNT	CONCRETE BASE
PHASES USED	2,4,5,6,4P,6P
OVERLAPS	OLA=Ø1+Ø2, OLB=Ø3+Ø4, OLC=Ø5+Ø6, OLD=Ø7+Ø8

- NOTES:
- ALL PEDESTRIAN SIGNAL HEADS SHALL BE 'COUNTDOWN' HEADS.
 - INSTALL BACKPLATES WITH RETROREFLECTIVE BORDERS ON ALL VEHICLE SIGNAL HEADS.
 - PEDESTRIAN PUSH BUTTON LIGHTS SHALL BE LATCHING.
 - PUSH BUTTONS SHALL BE WITHIN 18" OF SIDEWALK.

TABLE OF OPERATION

OPERATION SIGNAL HEAD #	PHASE IN OPERATION								FLASH	
	Ø1	Ø1	Ø2	Ø2	Ø3	Ø3	Ø4	Ø4		
2	---	---	G	G	---	---	---	---	R	Y
4	---	---	R	R	---	---	---	---	G	R
4,5con	---	---	R	R	---	---	---	---	G	R
5,6F	---	---	G	FY	---	---	---	---	R	Y
6	---	---	R	G	---	---	---	---	R	Y
4P	---	---	DW	DW	---	---	---	---	W	DRK
6P	---	---	DW	W	---	---	---	---	DW	DRK

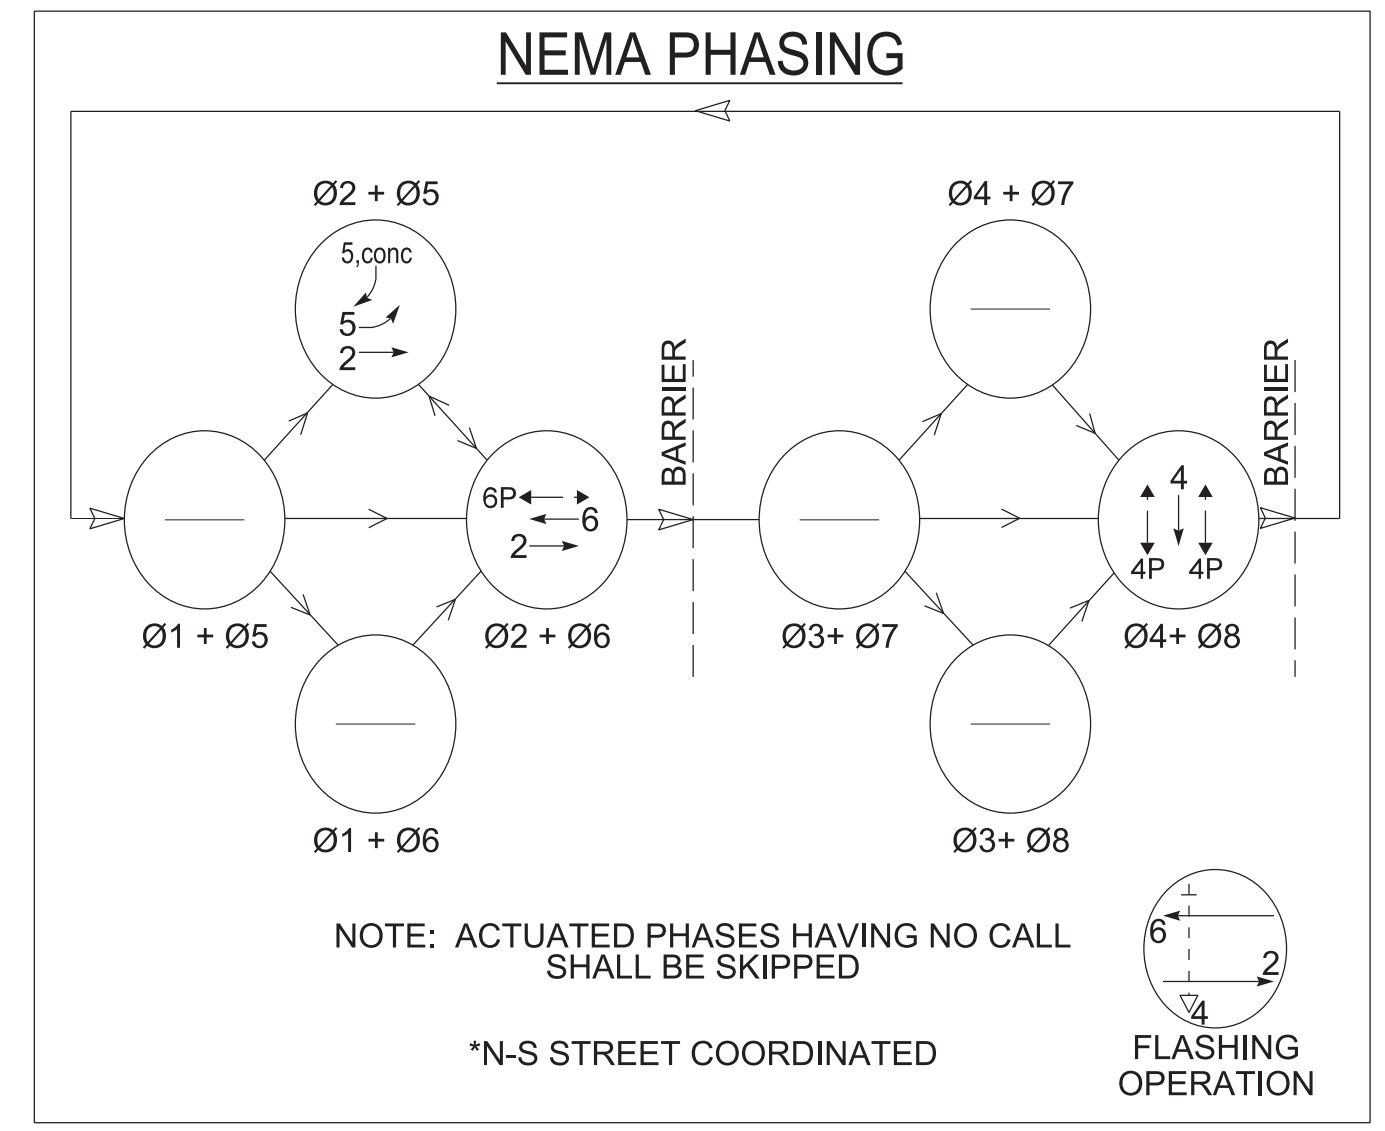- NOTES:
- THE LOCATION OF CONDUIT, JUNCTION BOXES, CABINETS, AND TRAFFIC SIGNAL POLES SHOWN ON THE PLAN ARE APPROXIMATE. THE CONTRACTOR SHALL CONTACT '811' AND ANY OTHER UTILITY COMPANIES NECESSARY TO VERIFY THE LOCATION OF ALL UNDERGROUND UTILITIES BEFORE DIGGING.
 - ALL EQUIPMENT, MATERIALS, AND WORKMANSHIP SHALL MEET THE STANDARDS OUTLINED IN THE MUTCD (LATEST EDITION), SCDOT STANDARD DRAWINGS, AND THE SCDOT TRAFFIC SIGNAL SPECIFICATIONS. ALL TRAFFIC SIGNAL EQUIPMENT AND MATERIALS REMOVED DURING THIS PROJECT SHALL BE RETURNED TO THE SCDOT OR DISPOSED OF AS DIRECTED BY THE ENGINEER.
 - THE CONTRACTOR IS REQUIRED TO MAINTAIN THE TRAFFIC SIGNAL OPERATION AT ALL TIMES DURING CONSTRUCTION OF THIS PROJECT. ALL COSTS FOR TEMPORARY SIGNAL EQUIPMENT AND TEMPORARY ADJUSTMENT OF THE TRAFFIC SIGNAL EQUIPMENT SHALL BE INCLUDED IN THE LINE ITEM BID FOR "TEMPORARY ADJUSTMENT OF TRAFFIC SIGNAL EQUIPMENT"
 - THE SIGNAL CONTRACTOR SHALL COORDINATE THE INSTALLATION OF NEW LOOPS WITH THE PAVEMENT MARKING CONTRACTOR.
 - DISTRICT 6 SIGNAL SHOP MUST BE CONTACTED PRIOR TO THE START OF ANY WORK.
 - CONDUIT AND SPLICE BOXES FOR THE SETBACK LOOPS SHOULD BE PLACED IN THE NEW SIDEWALK PRIOR TO POURING CONCRETE.
 - THE CONTRACTOR SHALL OBTAIN REQUIRED SOIL INFORMATION AND DESIGN THE POLE FOUNDATIONS AS PART OF THE UNIT BID PRICE FOR THE MAST ARMS. THE CONTRACTOR SHALL VERIFY THAT THE SIGNAL POLE FOUNDATION WILL NOT CONFLICT WITH EXISTING UNDERGROUND UTILITIES PRIOR TO ORDERING TRAFFIC SIGNAL MAST ARMS. ANY DEVIATIONS TO THE SIGNAL POLE FOUNDATION LOCATION MAY REQUIRE MODIFICATIONS TO THE MAST ARM LENGTHS.
 - POWER FOR LUMINAIRES SHALL BE PROVIDED ON A SEPARATE CIRCUIT AND METER FROM THE TRAFFIC SIGNAL.




POLE CHART

POLE	NORTHING	EASTING	MAST ARM SPAN LENGTH
A	389066.9782	2102189.5866	44'
B	388989.7015	2102096.2232	46' / 66'



SIGNAL TIMINGS

INTERVAL	PHASE							
	1	2	3	4	5	6	7	8
WALK	---	---	---	7	---	7	---	---
DON'T WALK	---	---	---	20	---	23	---	---
MIN INITIAL	---	15	---	8	8	15	---	---
MAX INITIAL	---	---	---	---	---	---	---	---
ADD/VEH	---	---	---	---	---	---	---	---
VEH EXT	---	2.5	---	2.5	2.5	2.5	---	---
TIME BFR REDUC	---	---	---	---	---	---	---	---
TIME TO REDUC	---	---	---	---	---	---	---	---
MIN GAP	---	2.5	---	2.5	2.5	2.5	---	---
MAX LIMIT	---	70	---	30	30	70	---	---
MAXIMUM 2	---	---	---	---	---	---	---	---
YELLOW	---	4.0	---	4.0	4.0	4.0	---	---
RED CLEAR	---	2.7	---	2.6	2.7	2.7	---	---

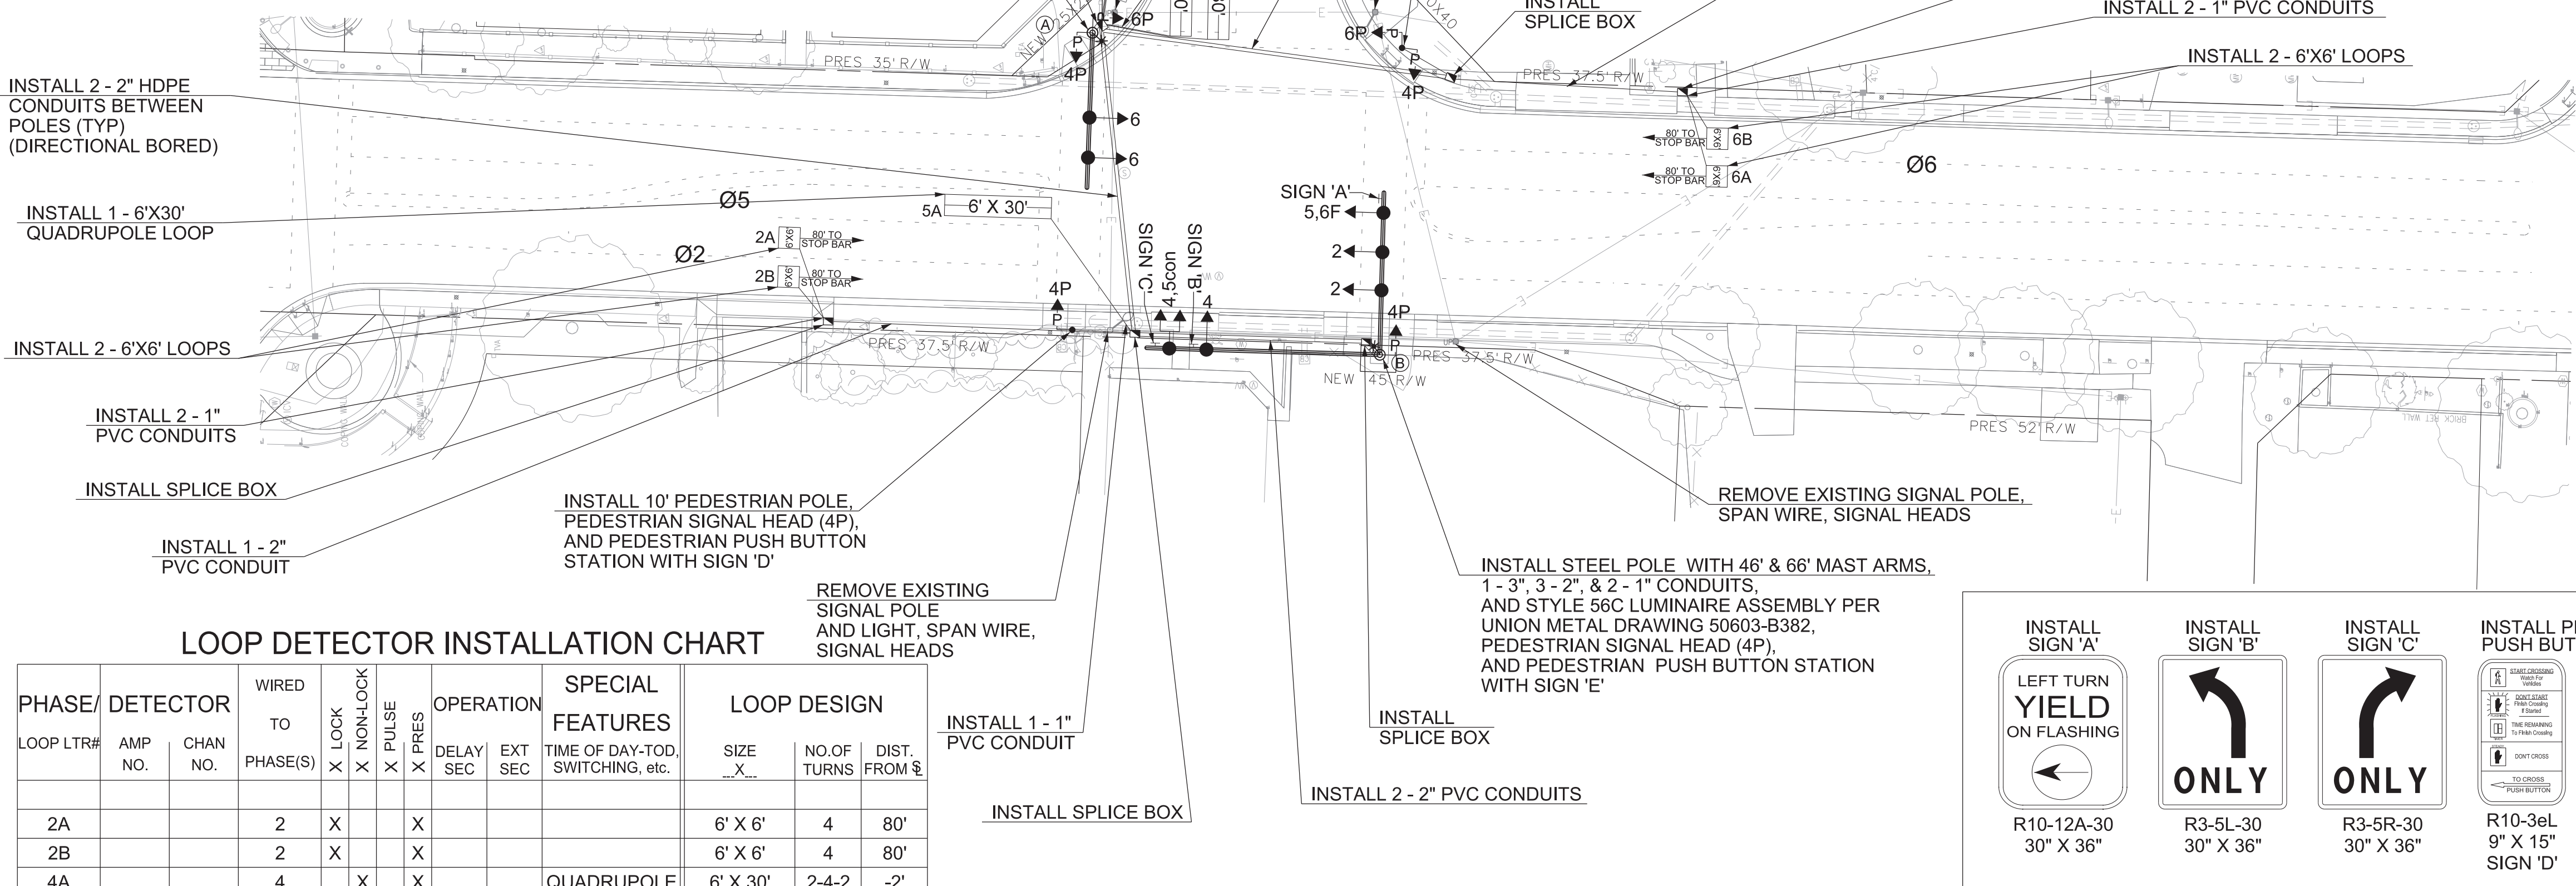

LOOP DETECTOR INSTALLATION CHART

PHASE/ LOOP LTR#	DETECTOR AMP NO.	CHAN NO.	WIRED TO				OPERATION	SPECIAL FEATURES	LOOP DESIGN		
			PHASE(S)	LOCK	NON-LOCK	PULSE			TIME OF DAY-TOD	SIZE	NO. OF TURNS
2A			2	X		X		6' X 6'	4	80'	
2B			2	X		X		6' X 6'	4	80'	
4A			4	X		X	QUADRUPOLE	6' X 30'	2-4-2	-2'	
4B			4	X		X	8	QUADRUPOLE	6' X 30'	2-4-2	-2'
5A			5	X		X		QUADRUPOLE	6' X 30'	2-4-2	-2'
6A			6	X		X		6' X 6'	4	80'	
6B			6	X		X		6' X 6'	4	80'	

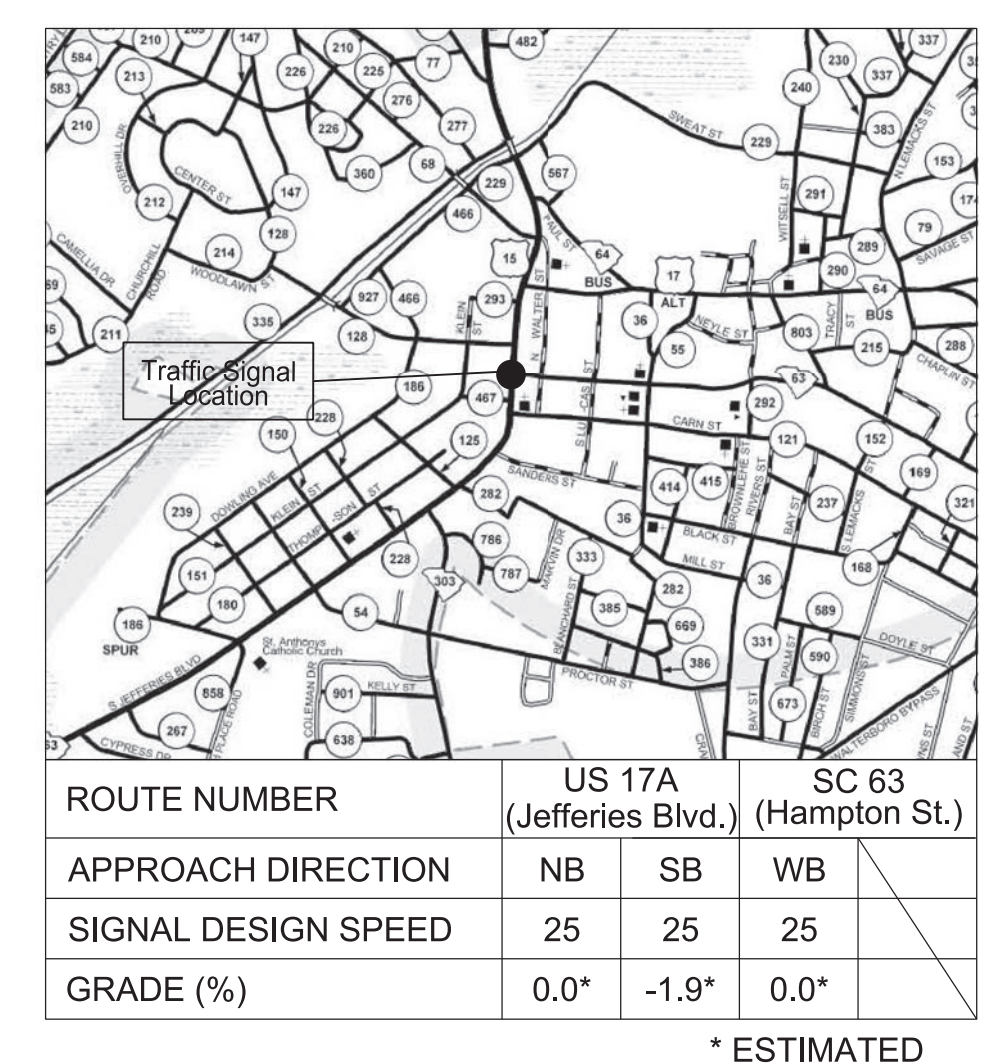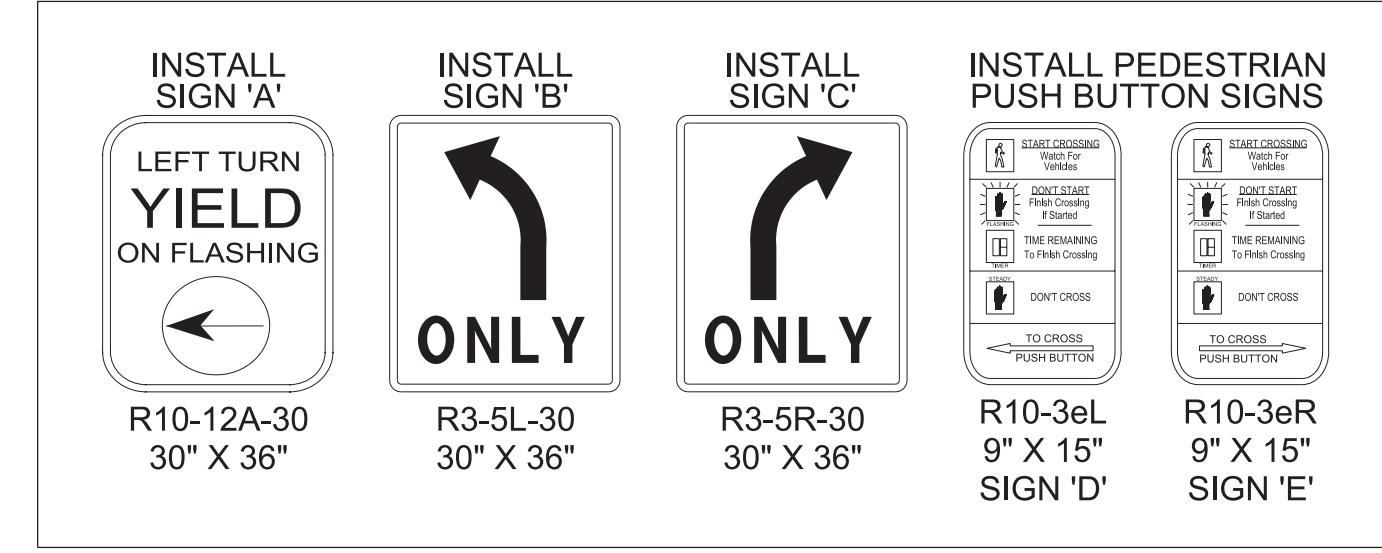


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SINCE 1954
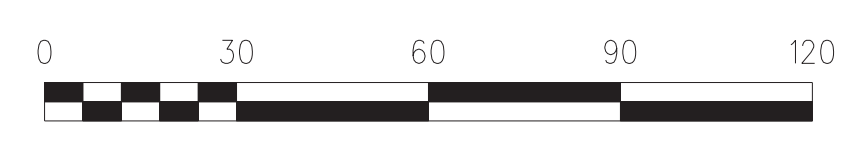
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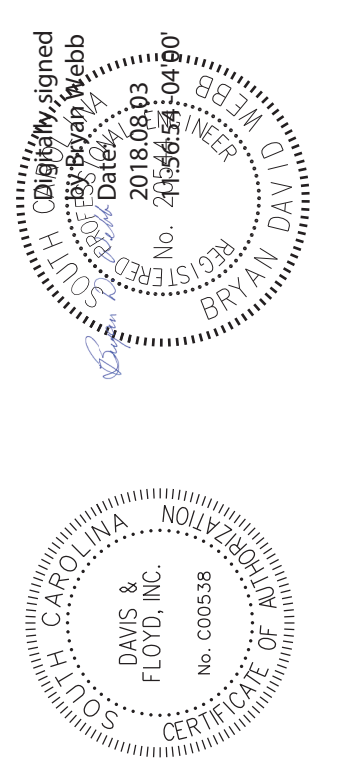


Wood+Partners Inc. WiPi
Landscape Architects
Land Planners



SCALE: 1" = 30'

PREPARED FOR:
I-95 BUSINESS LOOP PHASE 1B
Walterboro, South Carolina



DGN: LMT
R/W: CHK: BDW

REVISION	DATE	BY

SHEET NUMBER
TS3

10:49:46 AM FILE NAME: \CHS-F\SDData\Jobs\Even\31588-00\CV_dgn\ts3\ts3_SouthJeffries-Hampton.dgn PLOTTED: 8/3/2018

FED. RD. DIV. NO.	STATE	COUNTY	PROJECT ID	PROJECT NO.	ROUTE NO.	SHEET NO.	TOTAL SHEETS
3	S.C.	COLLETON	0041932	31588.00	SC 63	EC01	

SEEDING INSTALLATION

- A. Seed all disturbed areas of construction (excluding riprap lined ditches).
- B. No seeding should be undertaken in windy or unfavorable weather, when the ground is too wet to rake easily, when it is in a frozen condition, or too dry.
- C. The subgrade of all areas to be seeded shall be raked and all rubbish, sticks, roots, and stones larger than 2 IN shall be removed.
- D. Fertilizer shall be uniformly spread and disked or roto-tilled to a depth of at least 4 IN.
- E. Immediately following this preparation the seed shall be uniformly applied and lightly raked into the surface. Lightly roll the surface and water with fine spray. Seed shall be applied, depending on the period of year, at the rates indicated in Section 810 of the SCDOT Standard Specifications for Highway Construction (Edition 2007).

All seeded areas shall be mulched with clean small-grain straw at a rate of 1/2 to 2 tons per acre. Asphalt emulsion shall be applied uniformly at a rate of 300 GAL per acre to tack the mulch, unless otherwise shown on the plans. Mechanical tacking will be considered on a case-by-case basis as approved by the Engineer.
- F. All seeded areas shall be watered and maintained in good condition. Reseeding shall be done if and when necessary until a good, healthy, uniform growth is established over the entire area seeded.
- G. Slopes shall be protected against washouts by an approved method. Any washout which occurs shall be regraded and reseeded until good sod is established.

SEQUENCE OF CONSTRUCTION

- A. Obtain all permits.
- B. Contact the office of Ocean and Coastal Resource Management (OCRM) at (843)744-5838 prior to commencing construction activities.
- C. Install sediment erosion controls as follows:
 1. Silt Fences shall be used to prevent silt from leaving the limits of construction.
 2. Stabilized Graveled Construction Entrances shall be used at locations where construction vehicles access public non-construction areas. Vehicles shall be washed down as necessary to prevent tracking of silt off-site.
 3. A temporary rock filter dam or sediment tube shall be used as ditch checks as directed by the Engineer.
 4. Adhere to all of the OCRM Standard Notes listed on the right of this sheet and install BMP's per the SCDOT Standard Drawings for Erosion Control.
- D. A recommended sequence of construction follows:
 1. Clear and grub only areas necessary for perimeter erosion and sediment control, silt fence, hay bales, and temporary sediment traps.
 2. Construct perimeter controls.
 3. Construct new drainage appurtenances within the areas protected by perimeter controls.
 4. Install protection around inlets and stabilize disturbed areas as soon as possible (within 7 calendar days).
 5. Proceed with construction. Limit disturbed areas to areas with work in progress to limit disruption to traffic. Schedule work to maintain access to all driveways as long as possible.
 6. Erosion controls may be removed after the area contributing flow to that particular erosion control device has been stabilized.
 7. Stabilize all remaining areas.
 8. Clean out temporary sediment control as needed; check controls every seven (7) days.
 9. Remove sediment controls 30 days after all disturbed areas have stabilized.
- E. Submit Notice of Termination to SCDHEC.

STANDARD NOTES

1. If necessary, slopes which exceed eight (8) feet should be stabilized with synthetic or vegetative mats, in addition to hydroseeding. It may be necessary to install temporary slope drains during construction. Temporary berms may be needed until the slope is brought to grade.
2. Stabilization measures shall be initiated as soon as practicable in portions of the site where construction activities have temporarily or permanently ceased, but in no case more than fourteen (14) days after work has ceased, except as stated below:
*Where stabilization by the 14th day is precluded by snow cover or frozen ground conditions stabilization measures must be initiated as soon as practicable.
*Where construction activity on a portion of the site is temporarily ceased, and earth disturbing activities will be resumed within 14 days, temporary stabilization measures do not have to be initiated on that portion of the site.
3. All sediment and erosion control devices shall be inspected once every calendar week. If periodic inspection or other information indicates that a BMP has been inappropriately or incorrectly installed, the Permittee must address the necessary replacement or modification required to correct the BMP within 48 hours of identification.
4. Provide silt fence and or other control devices, as may be required, to control soil erosion during utility construction. All disturbed areas shall be cleaned, graded, and stabilized immediately after the utility installation. Fill, cover, and temporary seeding at the end of each day are recommended. If water is encountered while trenching, the water should be filtered to remove any sediments before being pumped back into any waters of the state.
5. All erosion control devices shall be properly maintained during all phases of construction until the completion of all construction activities and all disturbed areas have been stabilized. Additional control devices may be required during construction in order to control erosion and or offsite sedimentation. All temporary control devices shall be removed once construction is complete and the site is stabilized.
6. The contractor must take necessary action to minimize the tracking of mud onto paved roadway(s) from the construction area and the generation of dust. The contractor shall daily remove mud/soil from pavement, as may be required.
7. Residential subdivisions require erosion control features for infrastructure as well as for individual lot construction. Individual property owners shall follow these plans during construction or obtain approval of an individual plan in accordance with S.C. REG. 72-300 ET SEQ. and SCR100000.
8. Temporary diversion berms and or ditches will be provided as needed during construction to protect work areas from upslope runoff and or to divert sediment-laden water to appropriate traps or stable outlets.
9. All waters of the state (WOS), including wetlands, are to be flagged or otherwise clearly marked in the field. A double row of silt fence is to be installed in all areas where a 50-foot buffer can't be maintained between the disturbed area and all WOS. A 10-foot buffer should be maintained between the last row of silt fence and all WOS.
10. Litter, construction debris, oils, fuels, and building products with significant potential for impact (such as stockpiles of freshly treated lumber) and construction chemicals that could be exposed to storm water must be prevented from being a pollutant source in storm water discharges.
11. A copy of the SWPPP, inspection records, and rainfall data must be retained at the construction site or a nearby location easily accessible during normal business hours, from the date of commencement of construction activities to the date that final stabilization is reached.
12. Initiate stabilization measures on any exposed steep slope (3H:1V or greater) where land-disturbing activities have permanently or temporarily ceased, and will not resume for a period of 7 calendar days.
13. Minimize soil compaction and, unless infeasible, preserve topsoil.
14. Minimize the discharge of pollutants from equipment and vehicle washing, wheel wash water, and other wash waters. Wash waters must be treated in a sediment basin or alternative control that provides equivalent or better treatment prior to discharge.
15. Minimize the discharge of pollutants from dewatering of trenches and excavated areas. These discharges are to be routed through appropriate BMPs (sediment basin, filler bag, etc.).

16. The following discharges from sites are prohibited:
 - * Wastewater from washout of concrete, unless managed by an appropriate control;
 - * Wastewater from washout and cleanout of stucco, paint, form release oils, curing compounds and other construction materials;
 - * Fuels, oils, or other pollutants used in vehicle and equipment operation and maintenance; and
 - * Soaps or solvents used in vehicle and equipment washing.
17. After construction activities begin, inspections must be conducted at a minimum of at least once every calendar week and must be conducted until final stabilization is reached on all areas of the construction site.
18. If existing BMPs need to be modified or if additional BMPs are necessary to comply with the requirements of this permit and/or SC's Water Quality Standards, implementation must be completed before the next storm event whenever practicable. If implementation before the next storm event is impracticable, the situation must be documented in the SWPPP and alternative BMPs must be implemented as soon as reasonably possible.
19. A Pre-Construction Conference must be held for each construction site with an approved On-Site SWPPP prior to the implementation of construction activities. For non-linear projects that disturb 10 acres or more this conference must be held on-site unless the Department has approved otherwise.



STANDARD EROSION CONTROL DRAWINGS

DRAWING NO.	DRAWING DESCRIPTION	LATEST REVISION
815-001-01	TYPE A INLET STRUCTURE FILTERS	11/2016
815-006-00	TYPE F INLET STRUCTURE FILTERS	11/2016
815-605-00	TEMPORARY SILT FENCE	11/2016

Copies of SCDOT Standard Drawings are available at the following web address <http://www.scdot.org/business/standard-drawings.aspx>



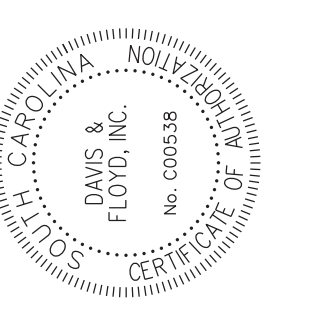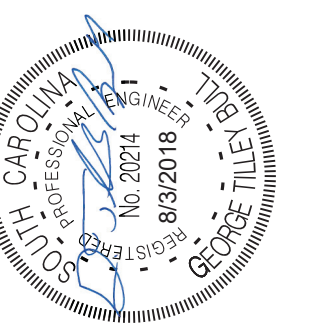**I-95 BUSINESS LOOP
PHASE 1B
EROSION CONTROL NOTES**
 Walterboro, South Carolina



DGN: LEK
R/W:
CHK: GTB

#	REVISION	DATE	BY

DAVIS & FLOYD
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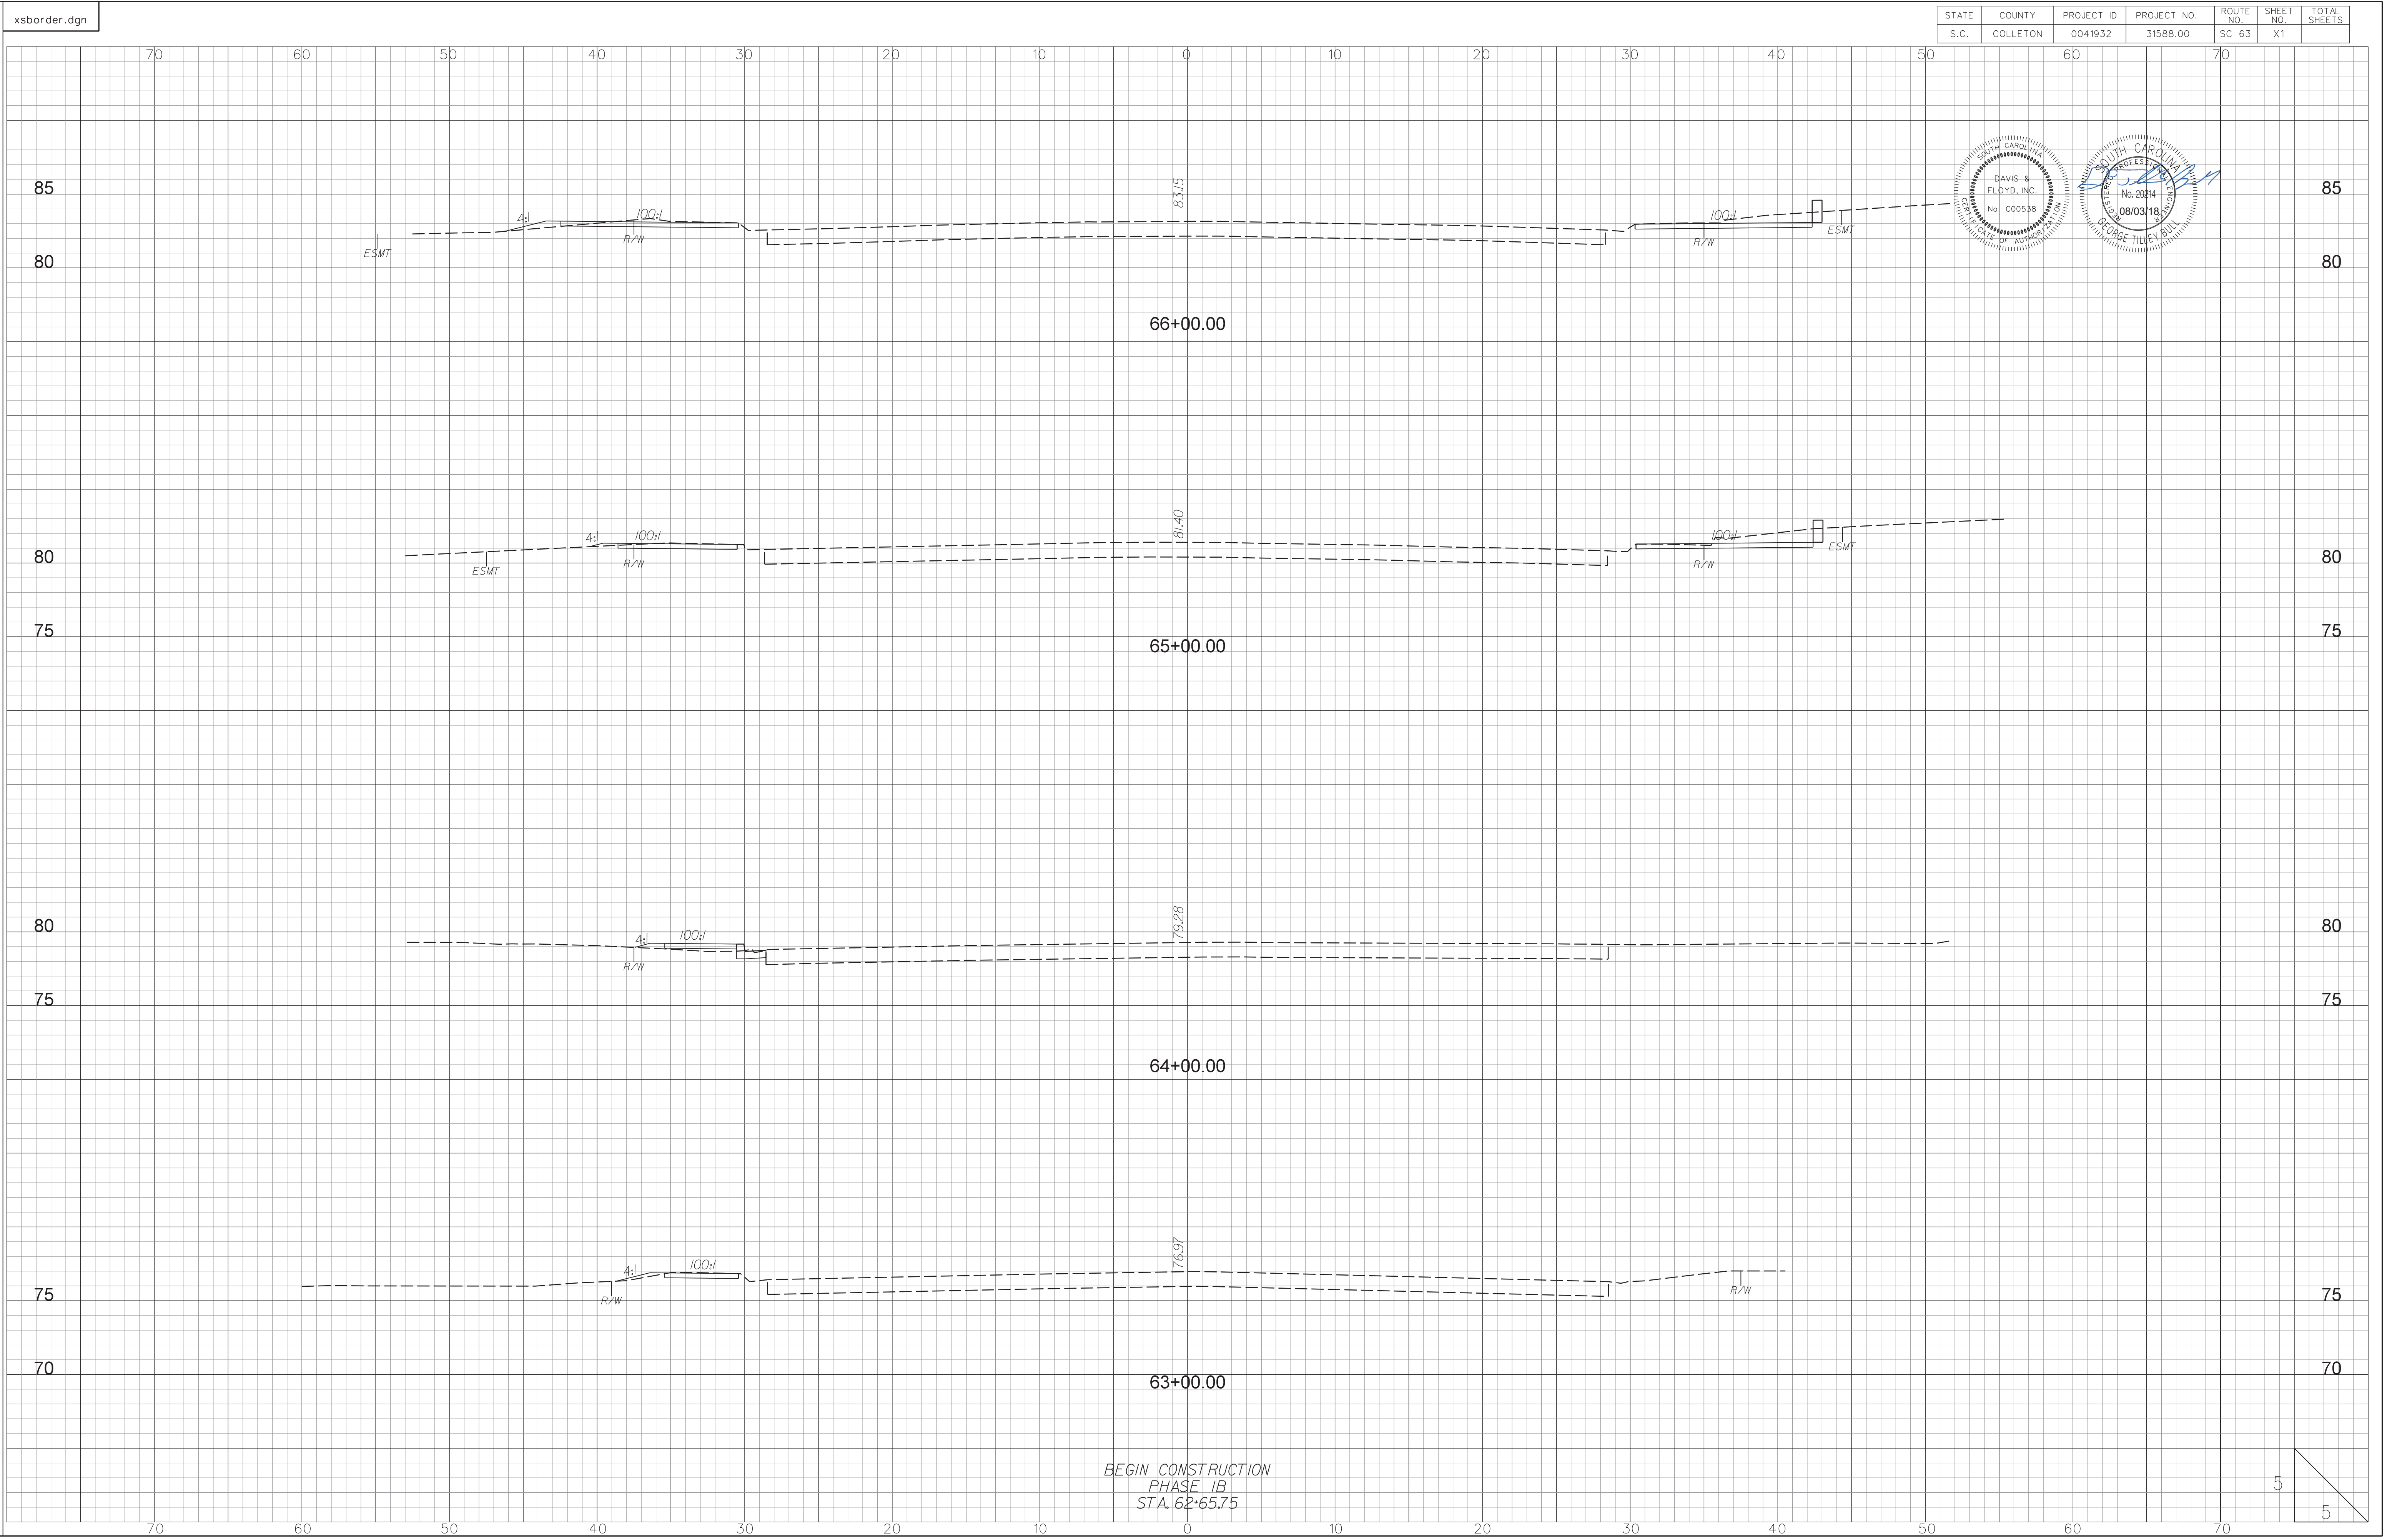
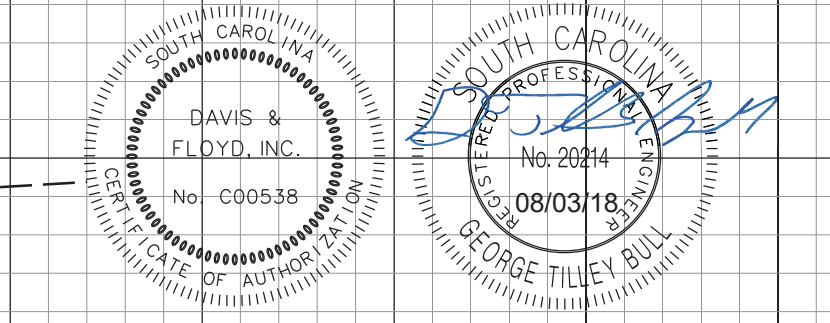
612 S Capeland Street ■ Tallahassee, FL 32304
850.391.0360 ■ Fax 850.396.1010 ■ www.woodandpartners.com

NTS

SHEET NUMBER
EC01



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S.C.	COLLETON	0041932	31588.00	SC 63	X1	



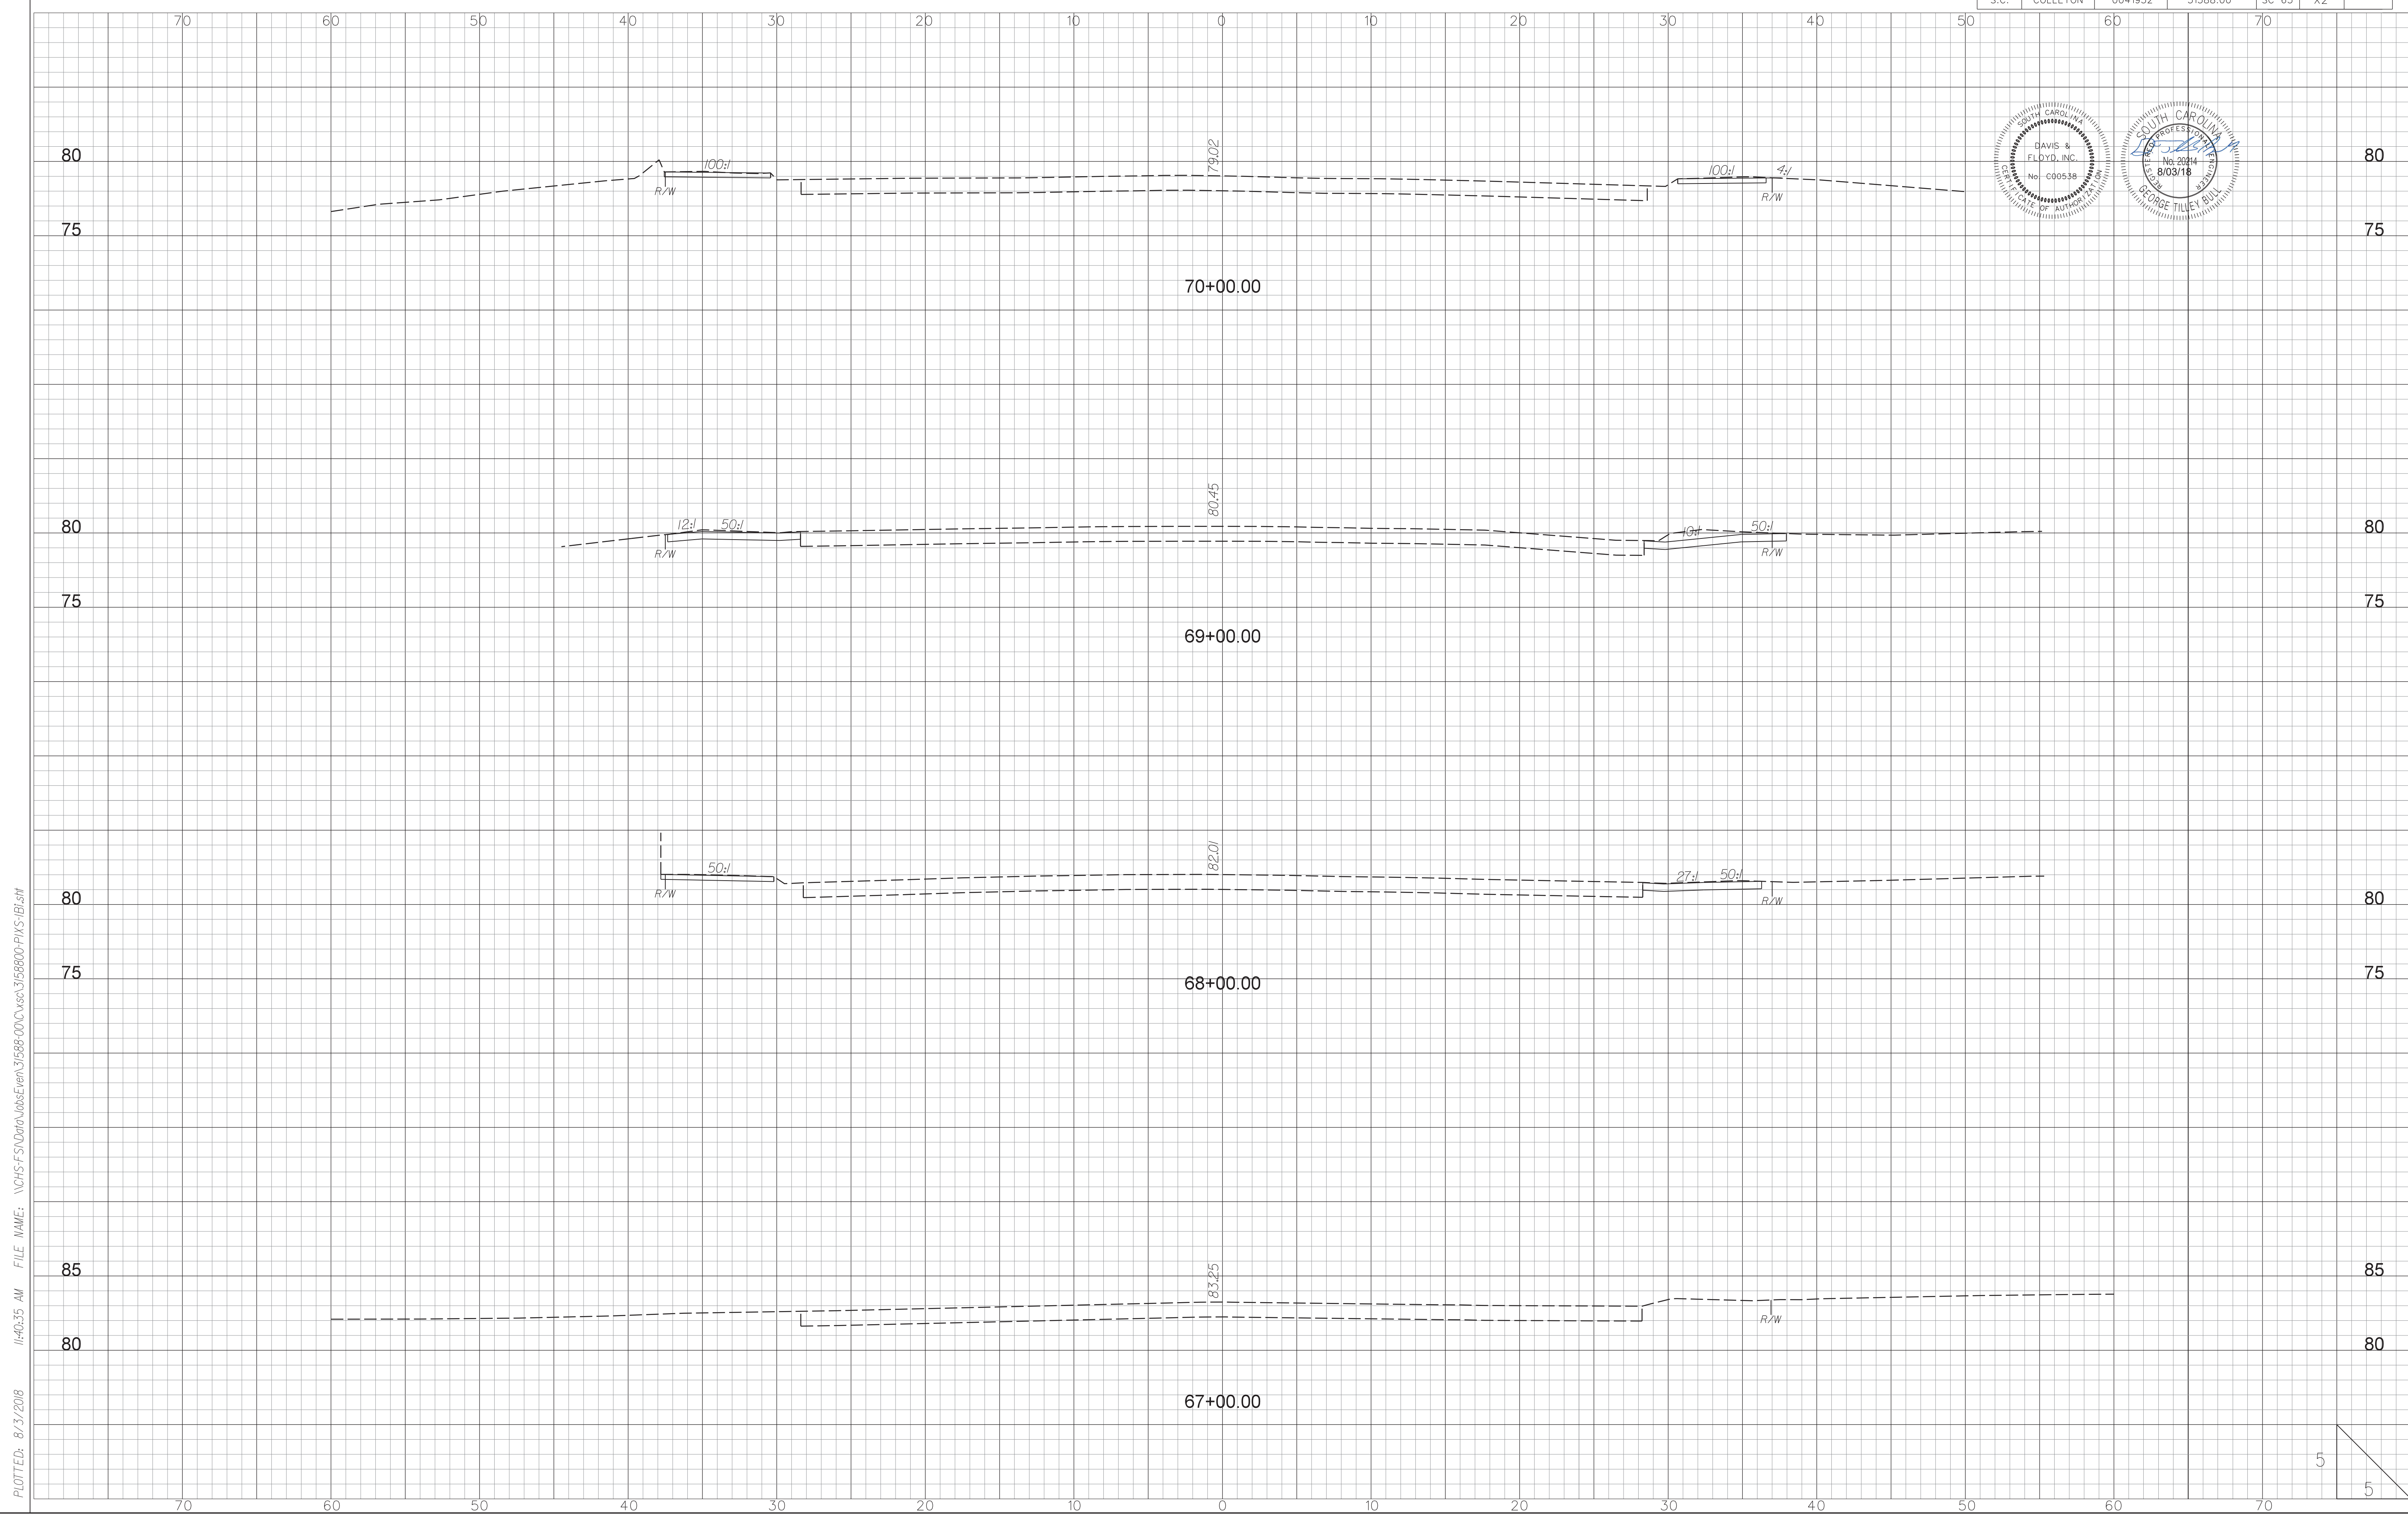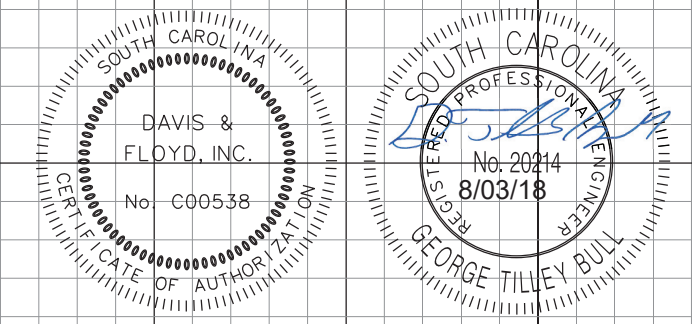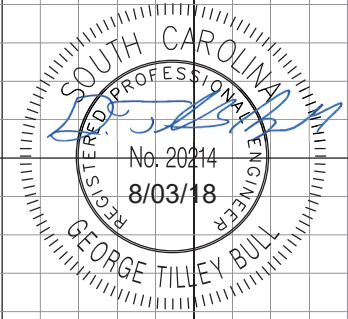
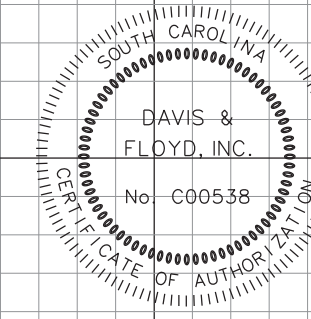
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